
# The Cottages at Point San Luis

San Luis Obispo County, California

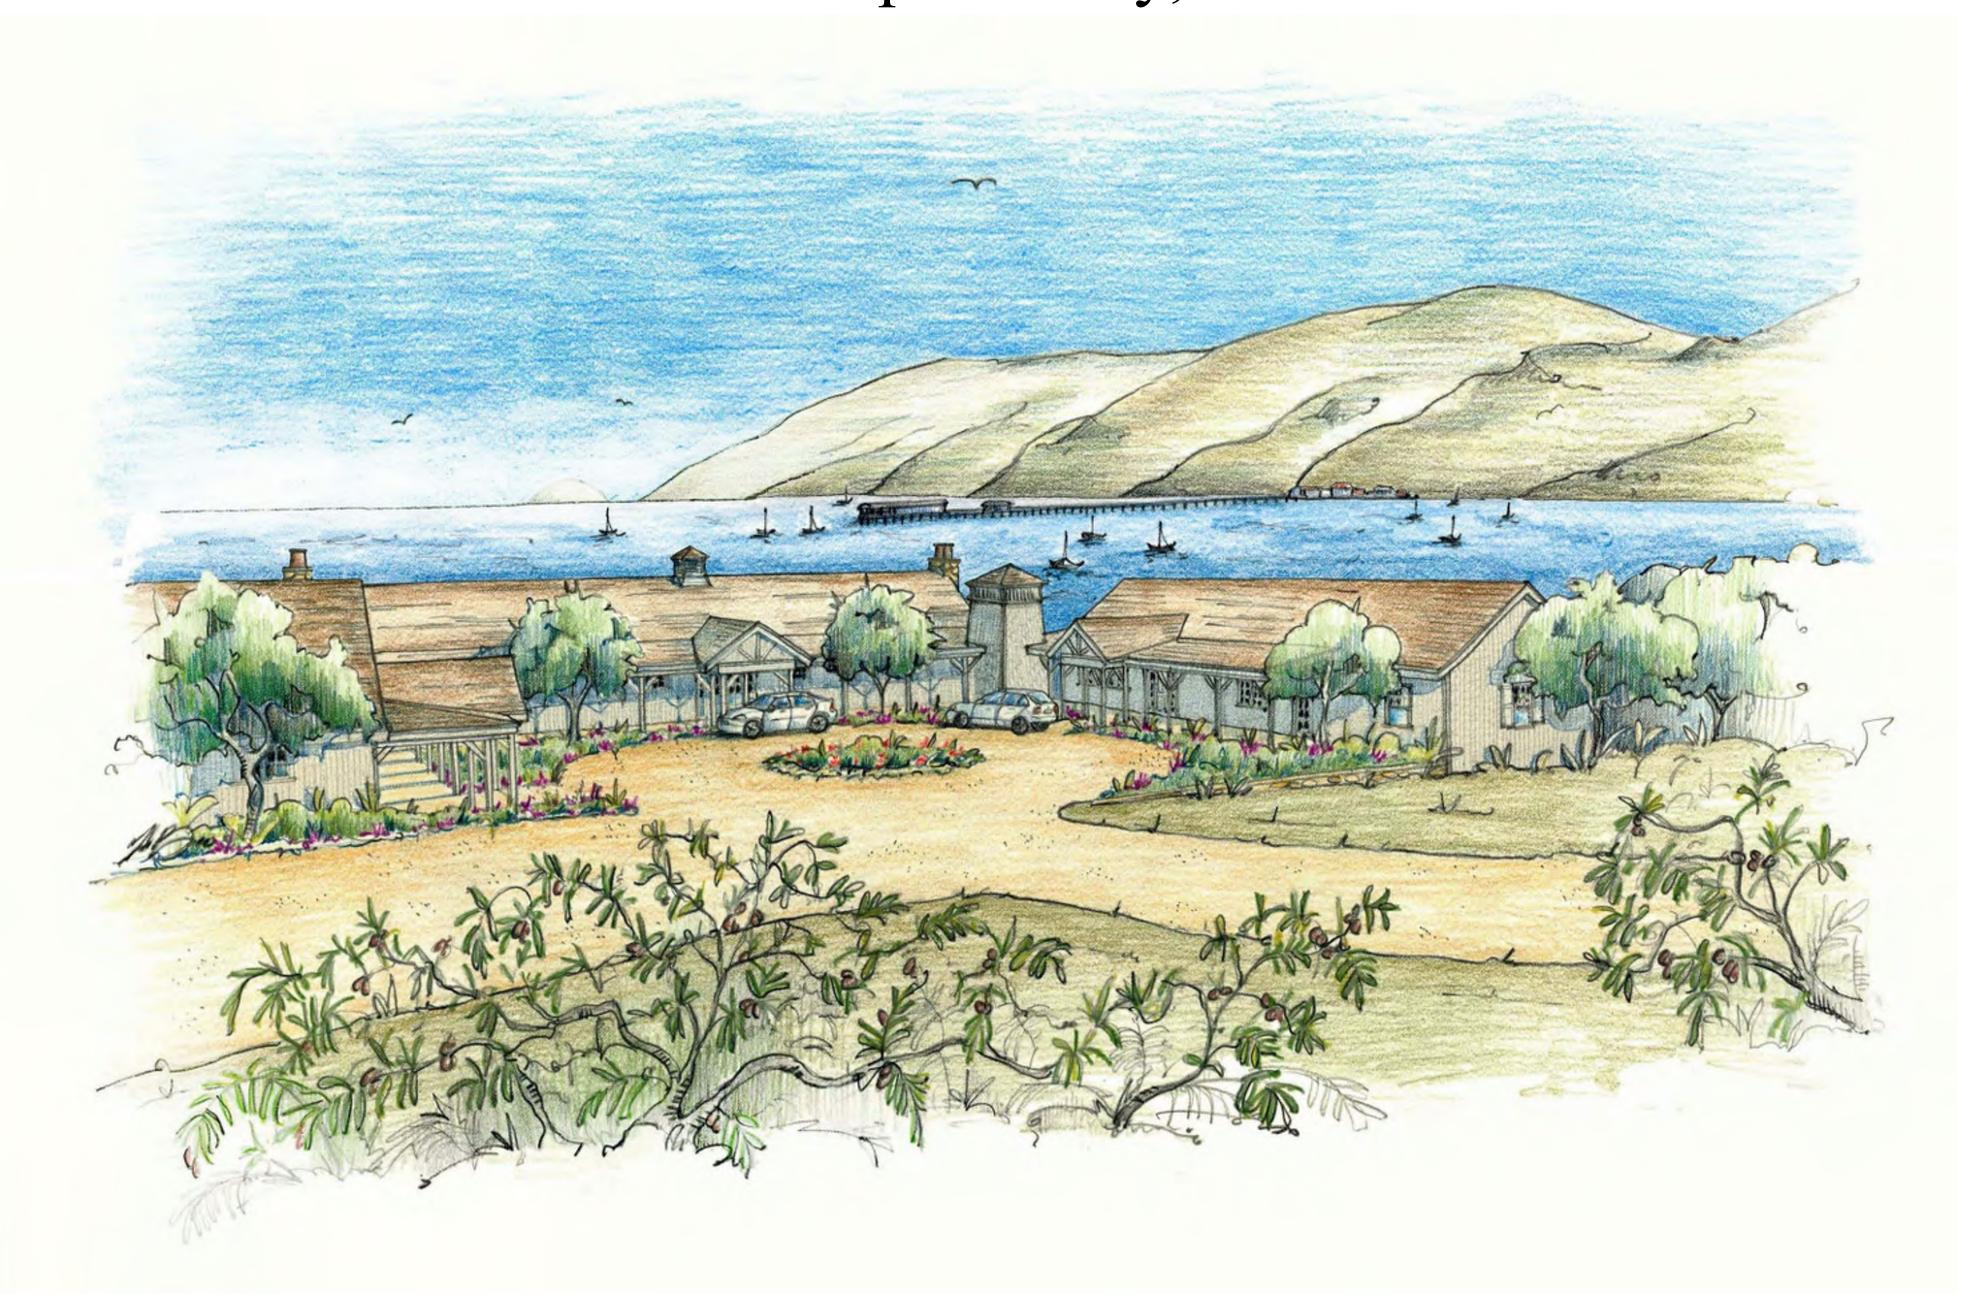

					NEW	SITE DEVELOPM	IENT AR	ΕΛC
					INT			LAS
Main Building Lodge	NET SQ. FT.	GROSS SQ. FT.	Cottage "D"	NET SQ. FT.	GROSS SQ. FT.		ACRES	SQ. FT.
Main Level	8,909	9,491	Building .	485	556	Lot Size	22.25	969,212
Lower Level-Below Ground (31%)	6,018	6,308	Porches & Decks	~	215		22.23	1 303,212
Lower Level-Above Ground (69%)	13,396	14,039	TOTAL		771			1
TOTAL	28,323	29,838	Total for All Cottage "D" Types			Development Envelope Size	ACRES	SQ. FT.
Site Percentage (Above Ground Only)	0.92%	0.98%	Quantity of Cottage Type		15	Development Envelope Size	6.46	281,400
	~~~~~~~~~~~~~~~~~~~~~~~~~~~~~~~~~~~~~~	$\sim\sim\sim$	Percentage of Cottage Type	3	0%			
Entry Gate	NET SQ. FT.	GROSS SQ. FT.	Building	7,275	8,340	Proposed Parking		
Building	69	106	Porches & Decks	-	3,225	1 1		27
www. w. w.	mm n	un n m	TOTAL (Building, Porches, &Decks)	_	11,565	Above Ground Parking		37
West Parking Structure	1 ***	Q. FT.				Below Ground at Lodge		43
Below Ground (50%)	5	,105	Cottage "E"	NET SQ. FT.	GROSS SQ. FT.	West Parking Structure	,	87
Above Ground (50%)	5	,105	Building	523	597	Total	1	167
TOTAL	10	),209	Porches & Decks	-	244		~ \\\\\\\\\\\\\\\\\\\\\\\\\\\\\\\\\\\\	
•	•		TOTAL	-	841	Earthwork	Cut (CY)	Fill (CY)
Solid Waste Storage	NET SQ. FT.	GROSS SQ. FT.	Quantity of Cottage Type	***************************************	9		<u> </u>	<del>                                     </del>
Building	288	337	Percentage of Cottage Type	1	8%	TOTAL Earthwork	20,300	18,000
<b>4</b>	J	. }	Building	4,707	5,373		Import (C. Y.)	) Export (C. Y
Cottage "A"	NET SQ. FT.	GROSS SQ. FT.	Porches & Decks	-	2,196		0	2,300
Building	415	480	TOTAL (Building, Porches, &Decks)	-	7,569			1
Porches & Decks		143						
TOTAL	-	623	Cottage "F"	NET SQ. FT.	GROSS SQ. FT.			
Total for All Cottage "B" Types	<u></u>		Building	845	949			
Quantity of Cottage Type		1	Porches & Decks	-	394			
Percentage of Cottage Type		2%	TOTAL	-	1,343			
Building	415	480	Total for All Cottage "F" Types		·* · · · · · · · · · · · · · · · · · ·			
Porches & Decks	-	143	Quantity of Cottage Type		5			
TOTAL (Building, Porches, &Decks)	_	623	Percentage of Cottage Type	1	0%			
		•	Building	4,225	4,745			
Cottage "B"	NET SQ. FT.	GROSS SQ. FT.	Porches & Decks	-	1,970			
Building	456	517	TOTAL (Building, Porches, &Decks)	-	6,715			
Porches & Decks		140			-d			
TOTAL	-	657	TOTAL Cottages on Site	NET SQ. FT.	GROSS SQ. FT.			
Total for All Cottage "B" Types	•	•	Total Quantity of Cottages		50			
Quantity of Cottage Type		9	Building	26,402	30,114			
Percentage of Cottage Type	1	18%	Porches & Decks	_	11,115			
Building	4,104	4,653	TOTAL	26,402	41,229			
Porches & Decks	-	1,260	Site Percentage (Buildings Only)	2.72%	3.11%			
TOTAL (Building, Porches, &Decks)	-	5,913	Site Percentage (Buildings, Porches, &	Decks)	4.25%			
					~ ~~~~~~~~~~~~~~~~~~~~~~~~~~~~~~~~~~~~	h.,		
Cottage "C"	NET SQ. FT.	GROSS SQ. FT.	TOTAL All Building on Site	NET SQ. FT.	GROSS SQ. FT.	<b>b</b>		
Building	516	593	TOTAL Above Grade	35,668	40,048	}		
Porches & Decks	-	211	Site Percentage (Above Grade Only)	3.68%	4.13%	3		
TOTAL	-	804	TOTAL Above & Below Grade	55,082	60,395			
Total for All Cottage "C" Types		1.	λ.,		•	[ <del>]</del>		
Quantity of Cottage Type		11		\				
Percentage of Cottage Type	2	22%						
Building	5,676	6,523						
Porches & Decks	-	2,321						

TOTAL (Building, Porches, &Decks)

				<u> </u>	' ' ' ' ' ' ' ' ' ' ' ' ' ' ' ' ' ' ' '
Lot Size	ACRES	SQ. FT.		mpervious	AREA IN SQ. FT.
For Size	22.25	969,212		31dg Footprint - Main Building	20,347.00
				Bldg Footprint - Entry Gate	106.00
Davidanmant Envolona Sina	ACRES	SQ. FT.		31dg Footprint - Solid Waste Storage	337.00
Development Envelope Size	6.46	281,400	, 1	Bldg Footprint - Cottages	41,229.00
				FOTAL Bidgs Footprint	62,019.00
Proposed Parking				M M . M . M	me promise i
Above Ground Parking	3	37		Pool Deck	4,600.00
Below Ground at Lodge	4	13		Pool	1,250.00
West Parking Structure	8	37	] I	Roads	59,550.00
Total	11	67		Cart Path	9,650.00
~~~~~~~~~~~~~~~~~~~~~~~~~~~~~~~~~~~~~~~	\\\\\\\\\\\\\\\\\\\\\\\\\\\\\\\\\\\\\\	· \ \ \ \ \ \ \ \ \ \ \ \ \ \ \ \ \ \ \		Pedestrian Walkways	8,500.00
Earthwork	Cut (CY)	Fill (CY)	کر آ	FOTAL Impervious Area	145,569.00
TOTAL Earthwork	20,300	18,000	$\left  \begin{array}{c} 1 \\ 1 \end{array} \right $	Total Site Percentage	15.02%
	Import (C. Y.)	Export (C. Y.)	$\mathbb{K}_{-}$		
	0	2,300	$\begin{cases} 1 \\ 1 \end{cases}$	Agency	
~~ \ \ \ \ \ \ \ \ \ \ \ \ \ \ \ \ \ \	1 1		] کر	Proposed Water Source	San Miguelito Mutual
			I	Proposed Sewer Disposal	San Miguelito Mutual
			Ī	Fire Agency	CalFire
			_		

		)		
print - Main Building	20,347.00		OWNER	_ CIVIL
print - Entry Gate	106.00	{	SCM Avila Beach Partners, LLC	Flowers & Associates, Inc.
print - Solid Waste Storage	337.00	3	115 W. Cannon Perdido St.	201 North Calle Cesar Chavez, Suite 100
print - Cottages	41,229.00	}	Santa Barbara, CA 93101	Santa Barbara, CA 93103
ldgs Footprint	62,019.00	}	(805) 681-0144	(805) 966 2224
1	, umy m		www.someracapital.com	www.flowersassoc.com
	4,600.00			
	1,250.00		Contact Donor	Contact Posses
	59,550.00		Contact Person	Contact Person
	9,650.00		David Brown	Robert Schmidt
Walkways	8,500.00		(805) 679-6343	(805) 966 2224 ext. 123
npervious Area	145,569.00		dbrown@someracapital.com	raschmidt@flowersassoc.com
Percentage	15.02%			
			PLANNING	_
			Suzanne Elledge Planning & Perm	- itting
Water Source	San Miguelito Mutual		Services, Inc.	
Sewer Disposal	San Miguelito Mutual		1625 State Street, Suite 1	
су	CalFire		Santa Barbara, CA 93101	
		•	(805) 966-2758	
			www.sepps.com	
			Contact Person	
			Steve Welton	
			(805) 966-2758 ext. 111	
			steve@sepps.com	
			sie ve wasppore om	
			A malaita at 0- A mala	site at Canaviltanta
			Architect & Arch	meet Consultants
			ARCHITECT	
			Appleton Partners, LLP	-
			117 W Micheltorena St	
			I	

Santa Barbara, CA 93101

www.appleton-architects.com

KMineau@Appleton-Architects.com

ph: (805) 965 0304

fax: (805) 560 6815

Contact Person

(805) 965 0304

Ken Mineau

PROJECT DIRECTORY

Owner & Owner Consultants

	,	
e 100	PROPOSED SITE  PACIFIC OCEAN	GENERAL CONDITIONS  A0.0 COVERSHEET  A0.1 SURVEY  ARCHITECTURAL  A1.1 OVERALL SITE PLAN  A1.2 CONCEPTUAL ILLUSTRATIVE (1/50) & LANDSCAPE NOTES  A1.3 CONCEPTUAL ILLUSTRATIVE (1/100)  A1.4 CONCEPTUAL ILLUSTRATIVE (1/500)  A2.1 MAIN LODGE UPPER LEVEL PLAN  A2.2 MAIN LODGE LOWER LEVEL PLAN  A2.3 MAIN LODGE ROOF PLAN  A3.1 MAIN LODGE ELEVATIONS  A3.2 MAIN LODGE ELEVATIONS  A3.2 MAIN LODGE ELEVATIONS  A4.1 COTTAGE TYPES "A" & "B"  A4.2 COTTAGE TYPES "C" & "D"  A4.3 COTTAGE TYPES "F" & "B"  A4.4 ENTRY GATE & SOLID WASTE STORAGE  A5.0 SITE PLAN - PARKING  A5.1 CRITICAL VIEWS  CIVIL  G-1 CIVIL - TITLE SHEET  EX-1 EXISTING CONDITIONS  C-1 GRADING & DRAINAGE PLAN  C-2 GRADING & DRAINAGE PLAN  C-3 GRADING & DRAINAGE PLAN  C-4 GRADING & DRAINAGE PLAN
	PROJECT DESCRIPTION	C-5 GRADING & DRAINAGE PLAN CD-1 MAIN ROAD SECTIONS CD-2 SPUR ROAD PROFILES
	A resort consisting of a Main Lodge (29,838 SF), which includes check-in, guest services (e.g. gift shop, fitness center, spa services), a restaurtant and bar a 1,250 sf pool, underground valet parking, and offices for the resort	MASTER FIRE PROTECTION PLAN MFPP-1 MASTER FIRE PROTECTION PLAN, OVERALL SITE PLAN MFPP-2 MASTER FIRE PROTECTION PLAN, COTTAGES

VICINITY MAP

I ROJECT DESCRIPTION	. <b>N</b>
A resort consisting of a Main Lodge (29,838 SF), which include guest services (e.g. gift shop, fitness center, spa services), a rest bar, a 1,250 sf pool, underground valet parking, and offices for staff. A series of (50) small, single-story Cottages, ranging from 949 SF. An Entry Gate and a Solid Waste Storage structure. A underground valet Parking Structure. Scope of work includes a site work, roads, parking spaces, and landscaping.	taurtant and the resort m 480 SF to partially

## PROJECT MATERIALS & COLORS

1) ROOF:	
2) EXTERIOR WALLS:	
3) DOORS:	
4) WINDOWS:	
5) GUTTERS & DOWNSPOUTS:	

FIRE PROOF SHAKE	
WOOD SIDING	
WOOD	
WOOD	
COPPER	

PROJECT 1	NFORMATION
<b>Legal Description</b>	<b>Location</b>
RHO SAN MIG PTN LT Y	Avila Beach
A.P.N. 076-174-009	San Luis Obispo, CA

MFPP-3 MASTER FIRE PROTECTION PLAN, MAIN LODGE

LANDSCAPE

**Zoning Code 1** REC

Sup. District


L1.1 LANDSCAPE - MAIN LODGE L1.2 LANDSCAPE - COTTAGES

L1.3 LANDSCAPE - NATIVE HABITAT

INDEX OF DRAWINGS

Lot Area 22.25 Acres Parking Spaces 167

Date: 03/27/2018 Scale: As indicated Drawn: PR Job Number: 1505.00

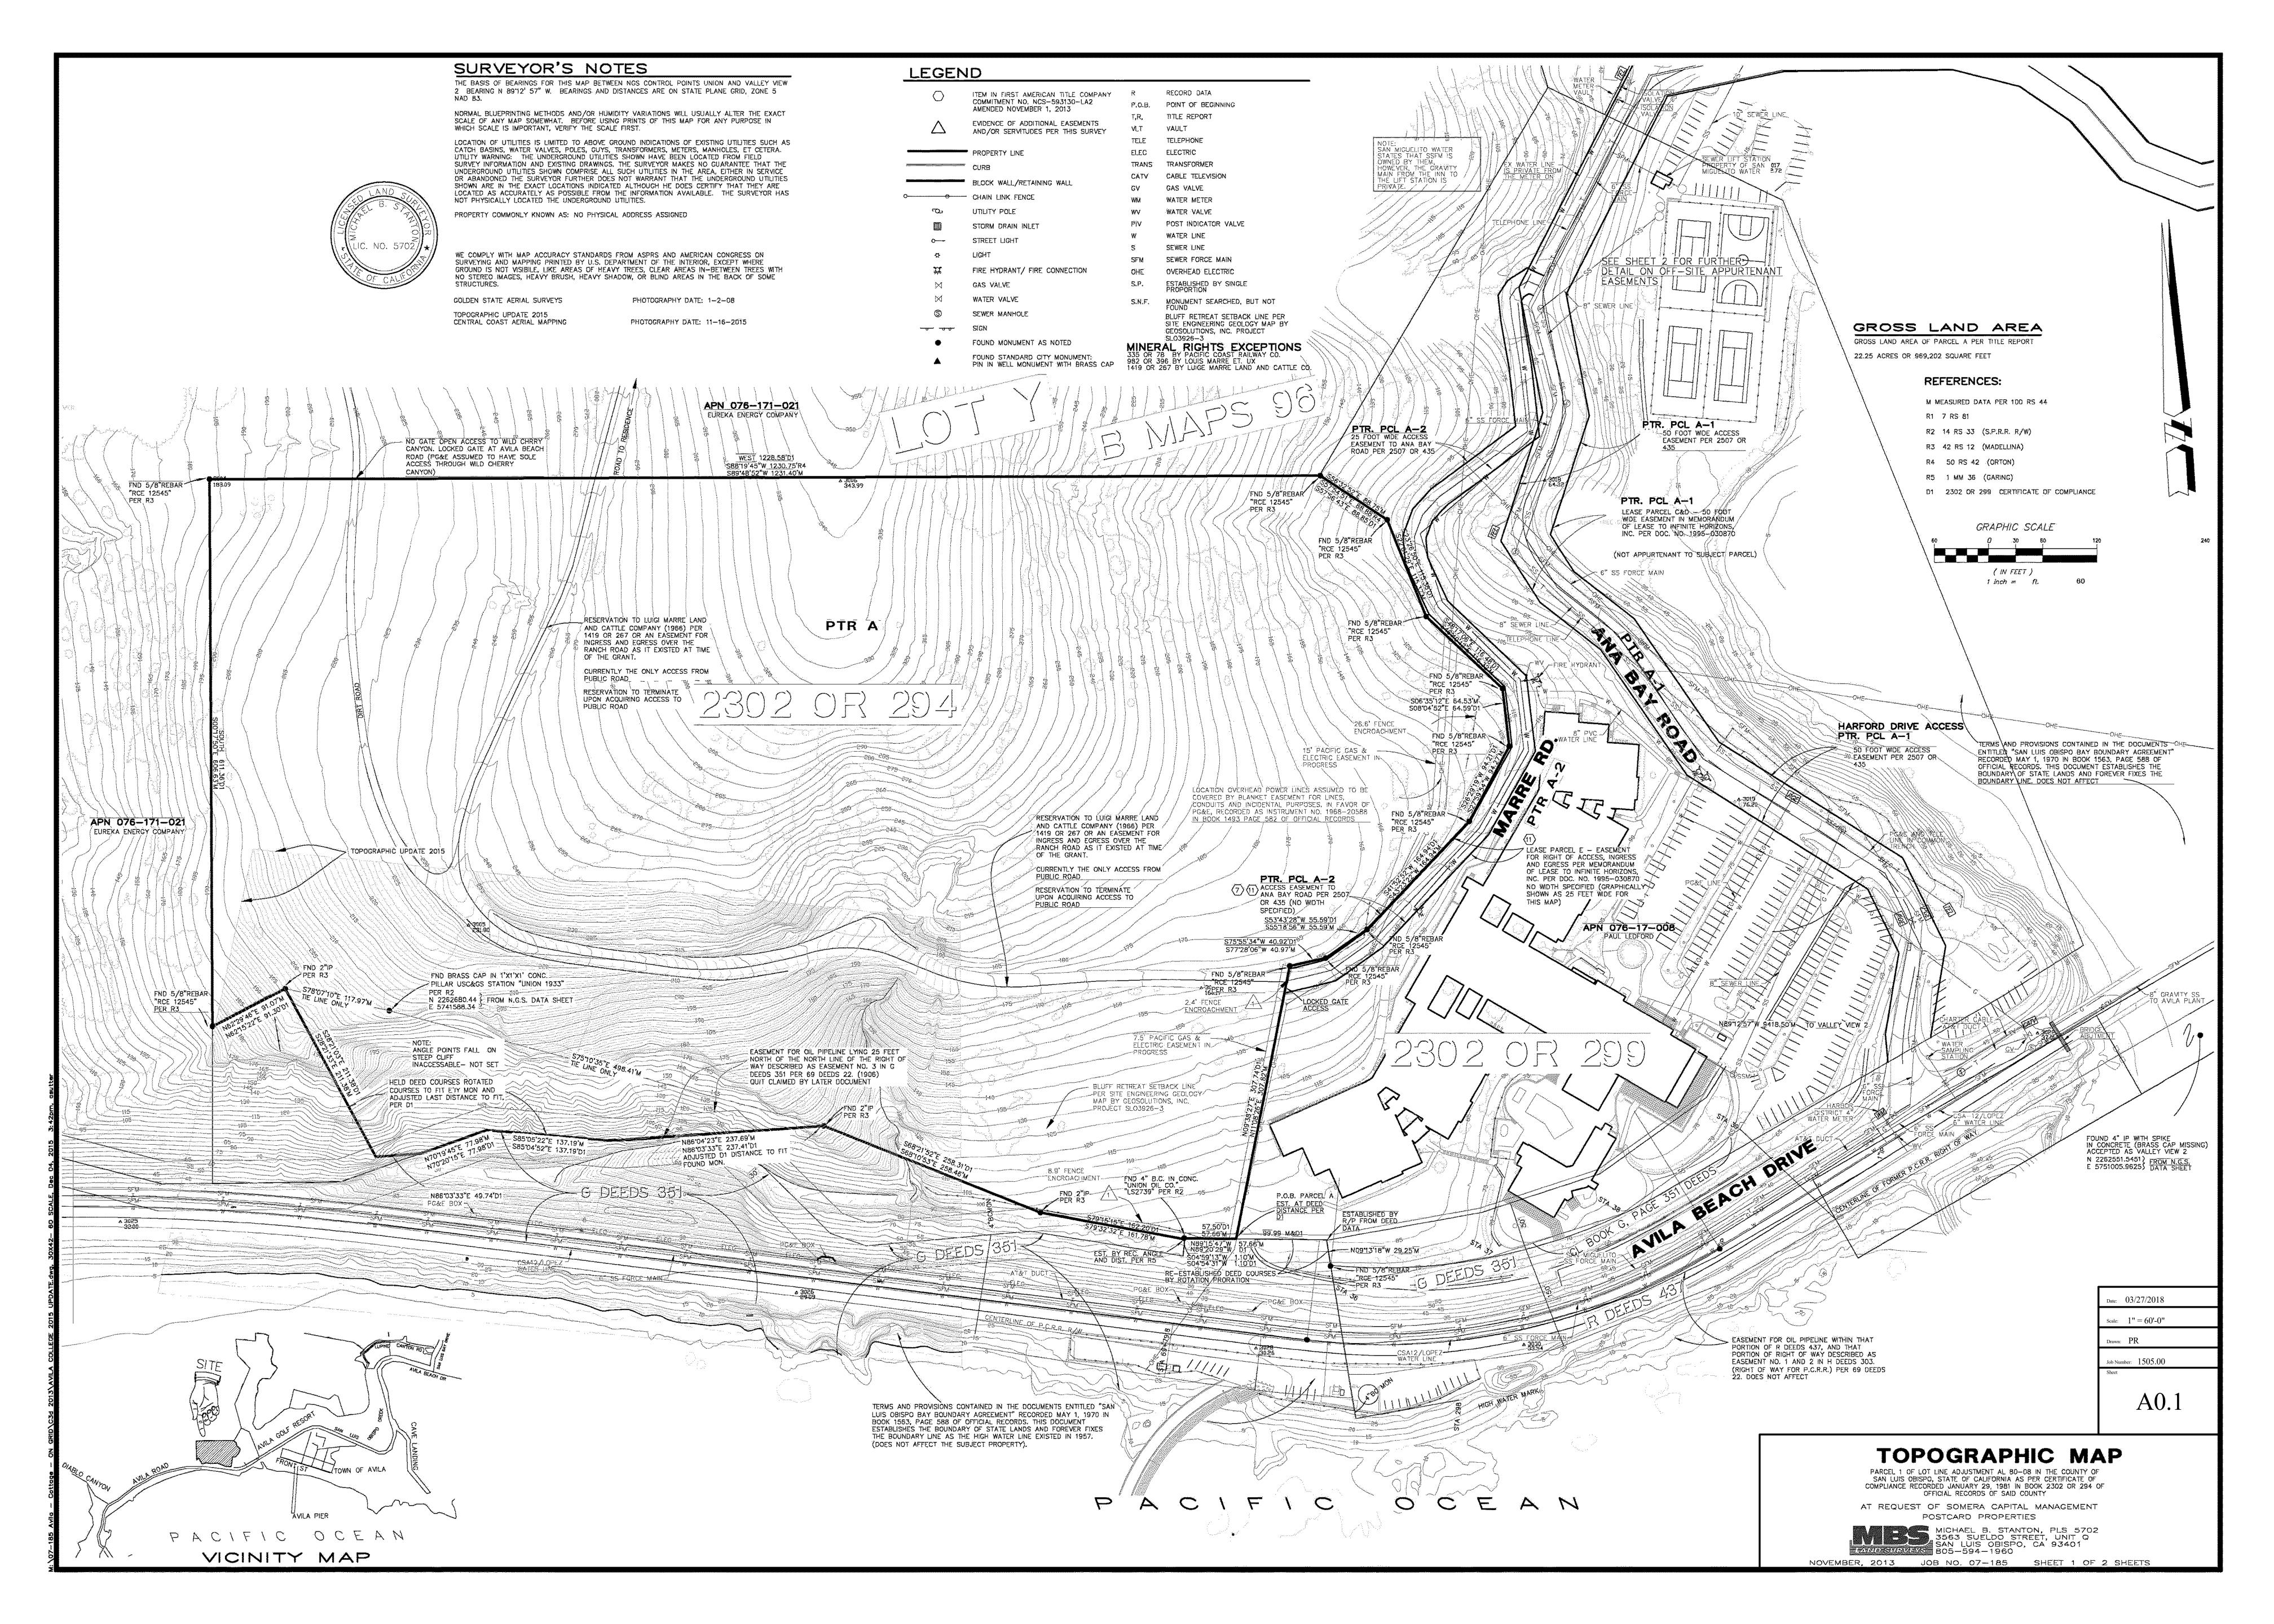



CONCEPTUAL ILLUSTRATIVE (1:50)

1" = 50'-0"

0' 25' 50' 100' 200'

SCALE: 1" = 50'-0"

The Cottages at Point San Luis

A DATE DESCRIPTION
03/27/18 PLANNING SUBMITTAL
09/24/18 PLANNING RESUBMITTAL

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violates the copyright laws of the United States
and will be subject to legal prosecution.

Date: 03/27/2018

Scale: 1" = 50'-0"

Scale: 1" = 50'-0"

Drawn: MW; PR

Job Number: 1505.00

A1.2

CONCEPTUAL ILLUSTRATIVE (1:100)
1" = 100'-0"



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A DATE DESCRIPTION

03/27/18 PLANNING SUBMITTAL


09/24/18 PLANNING RESUBMITTAL

Job Number: 1505.00

Date: 03/27/2018

Scale: 1" = 100'-0"

A1.3

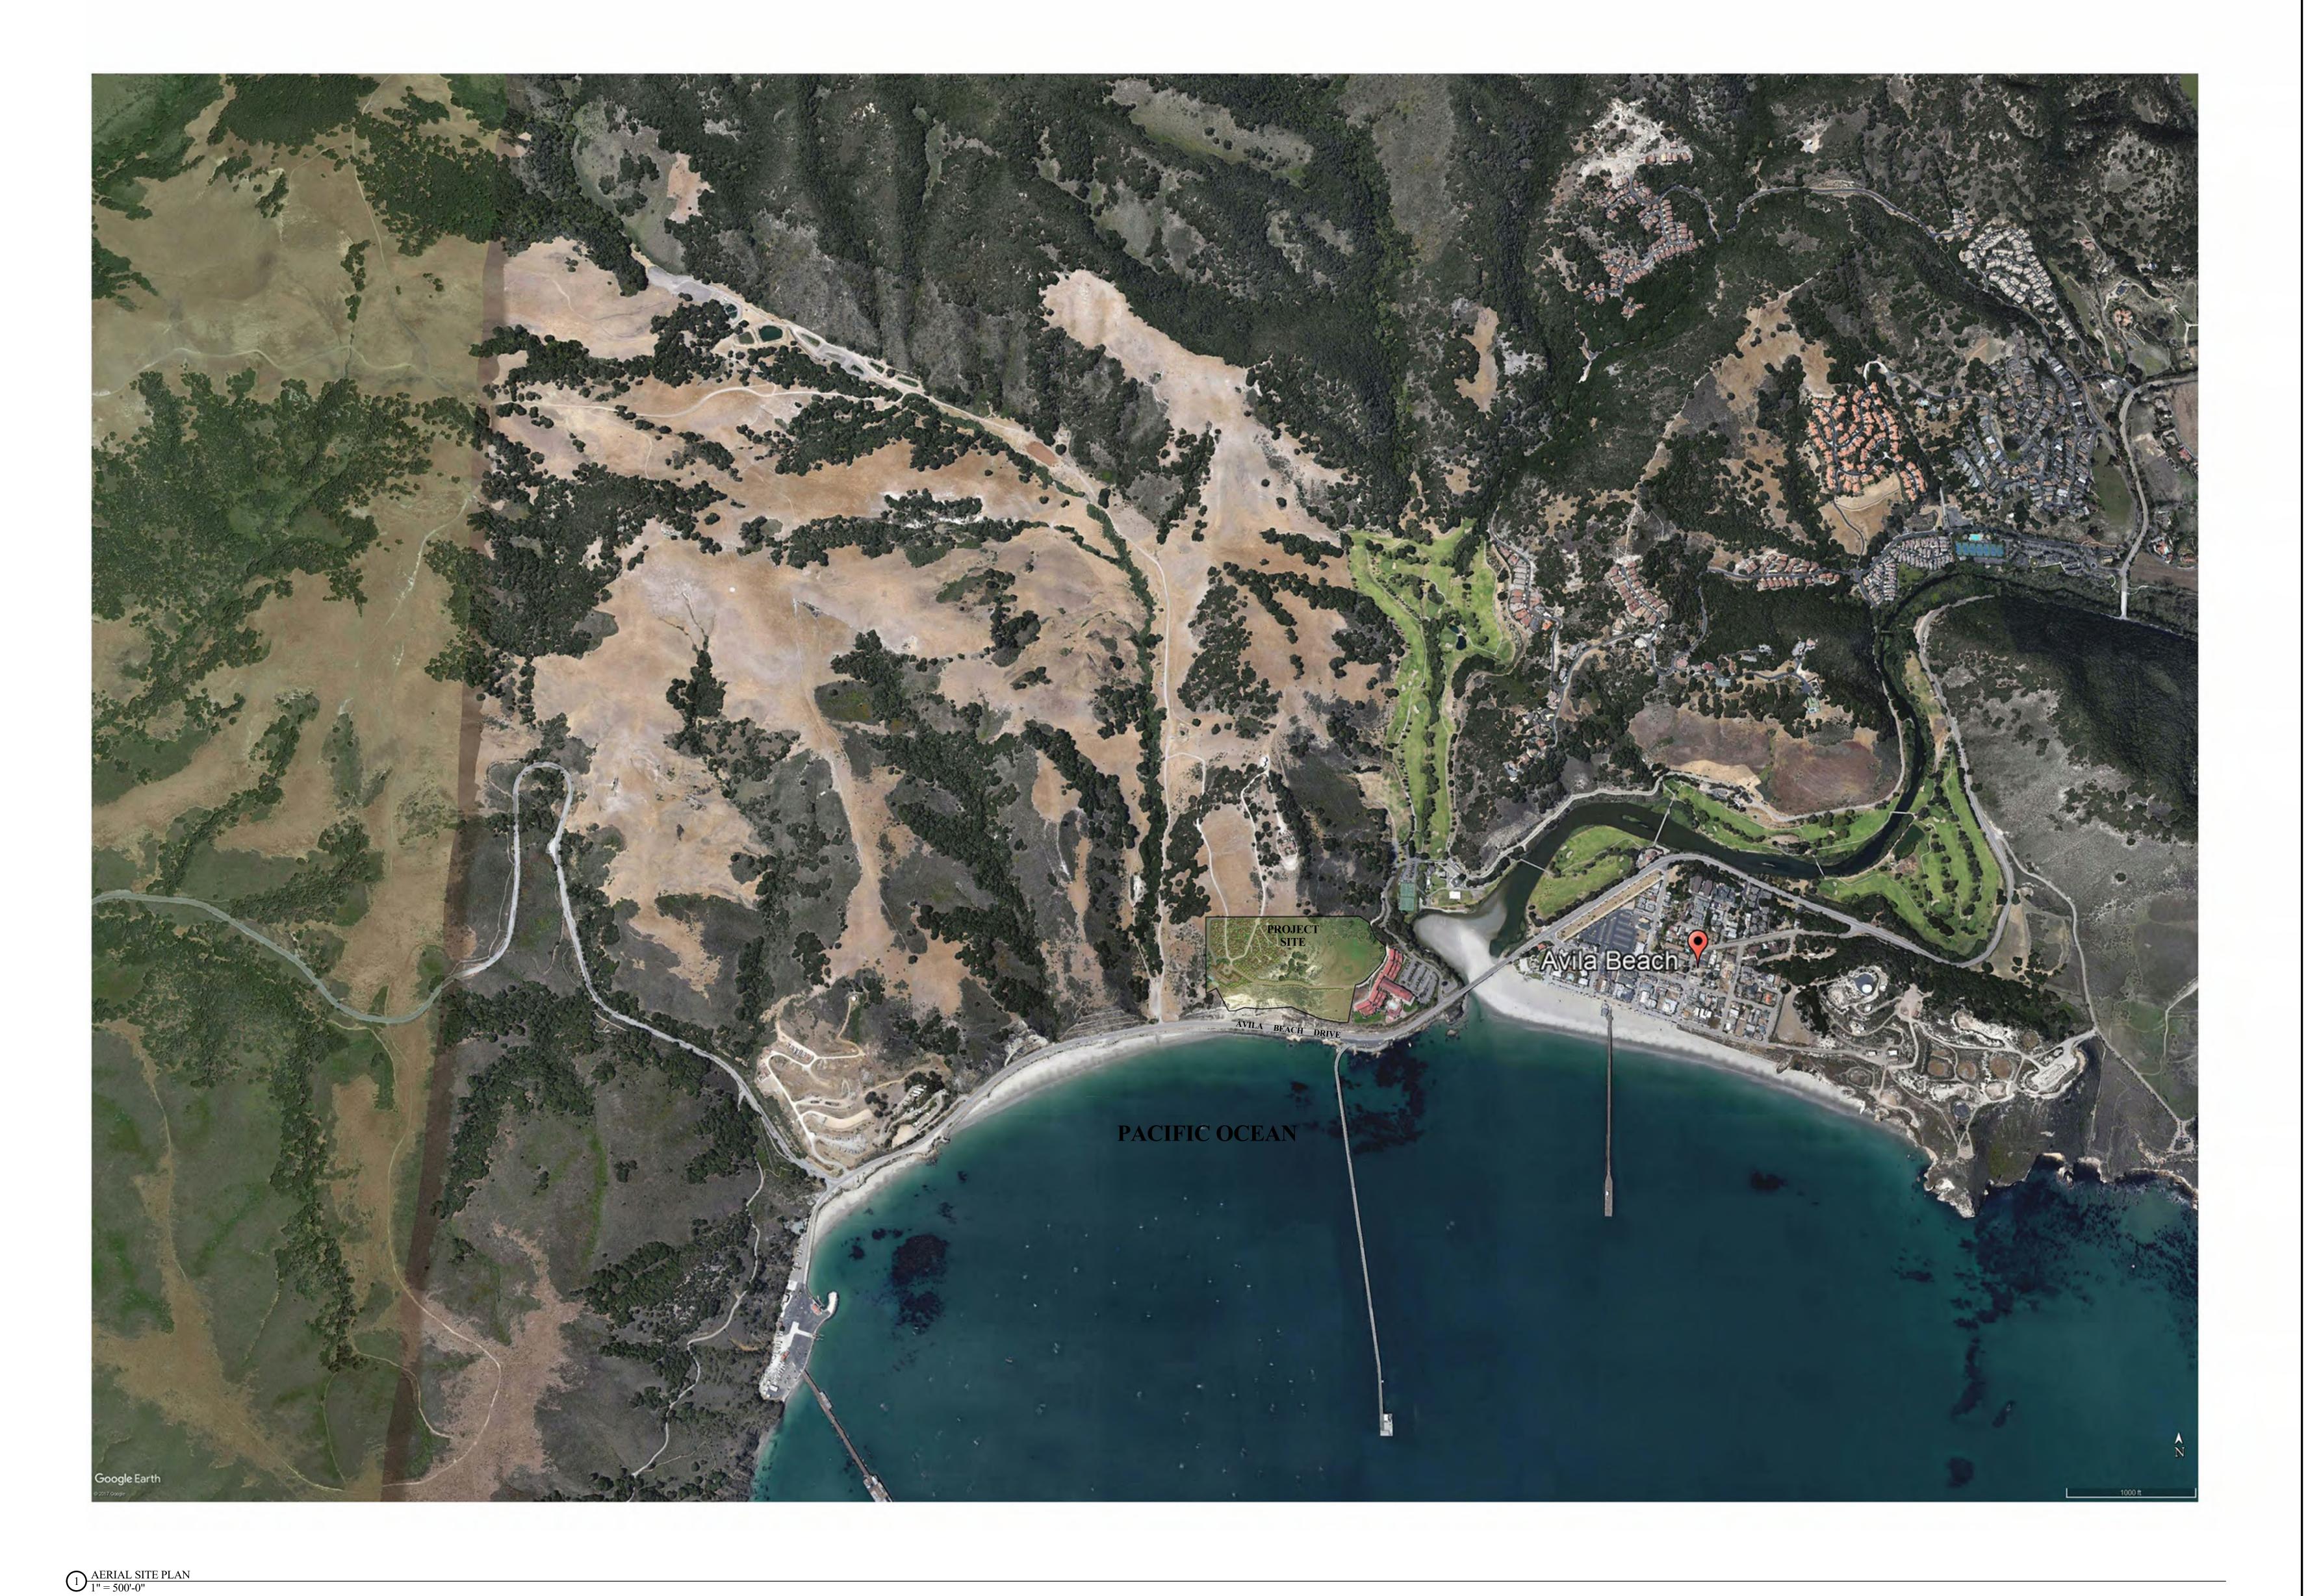


TRUE NORTH SCALE: 1" = 500'-0"


ΛDATEDESCRIPTION03/27/18PLANNING SUBMITTAL09/24/18PLANNING RESUBMITTAL


Date: 03/27/2018


Scale: 1'' = 500'-0''Drawn: MW; PR Job Number: 1505.00

A1.4

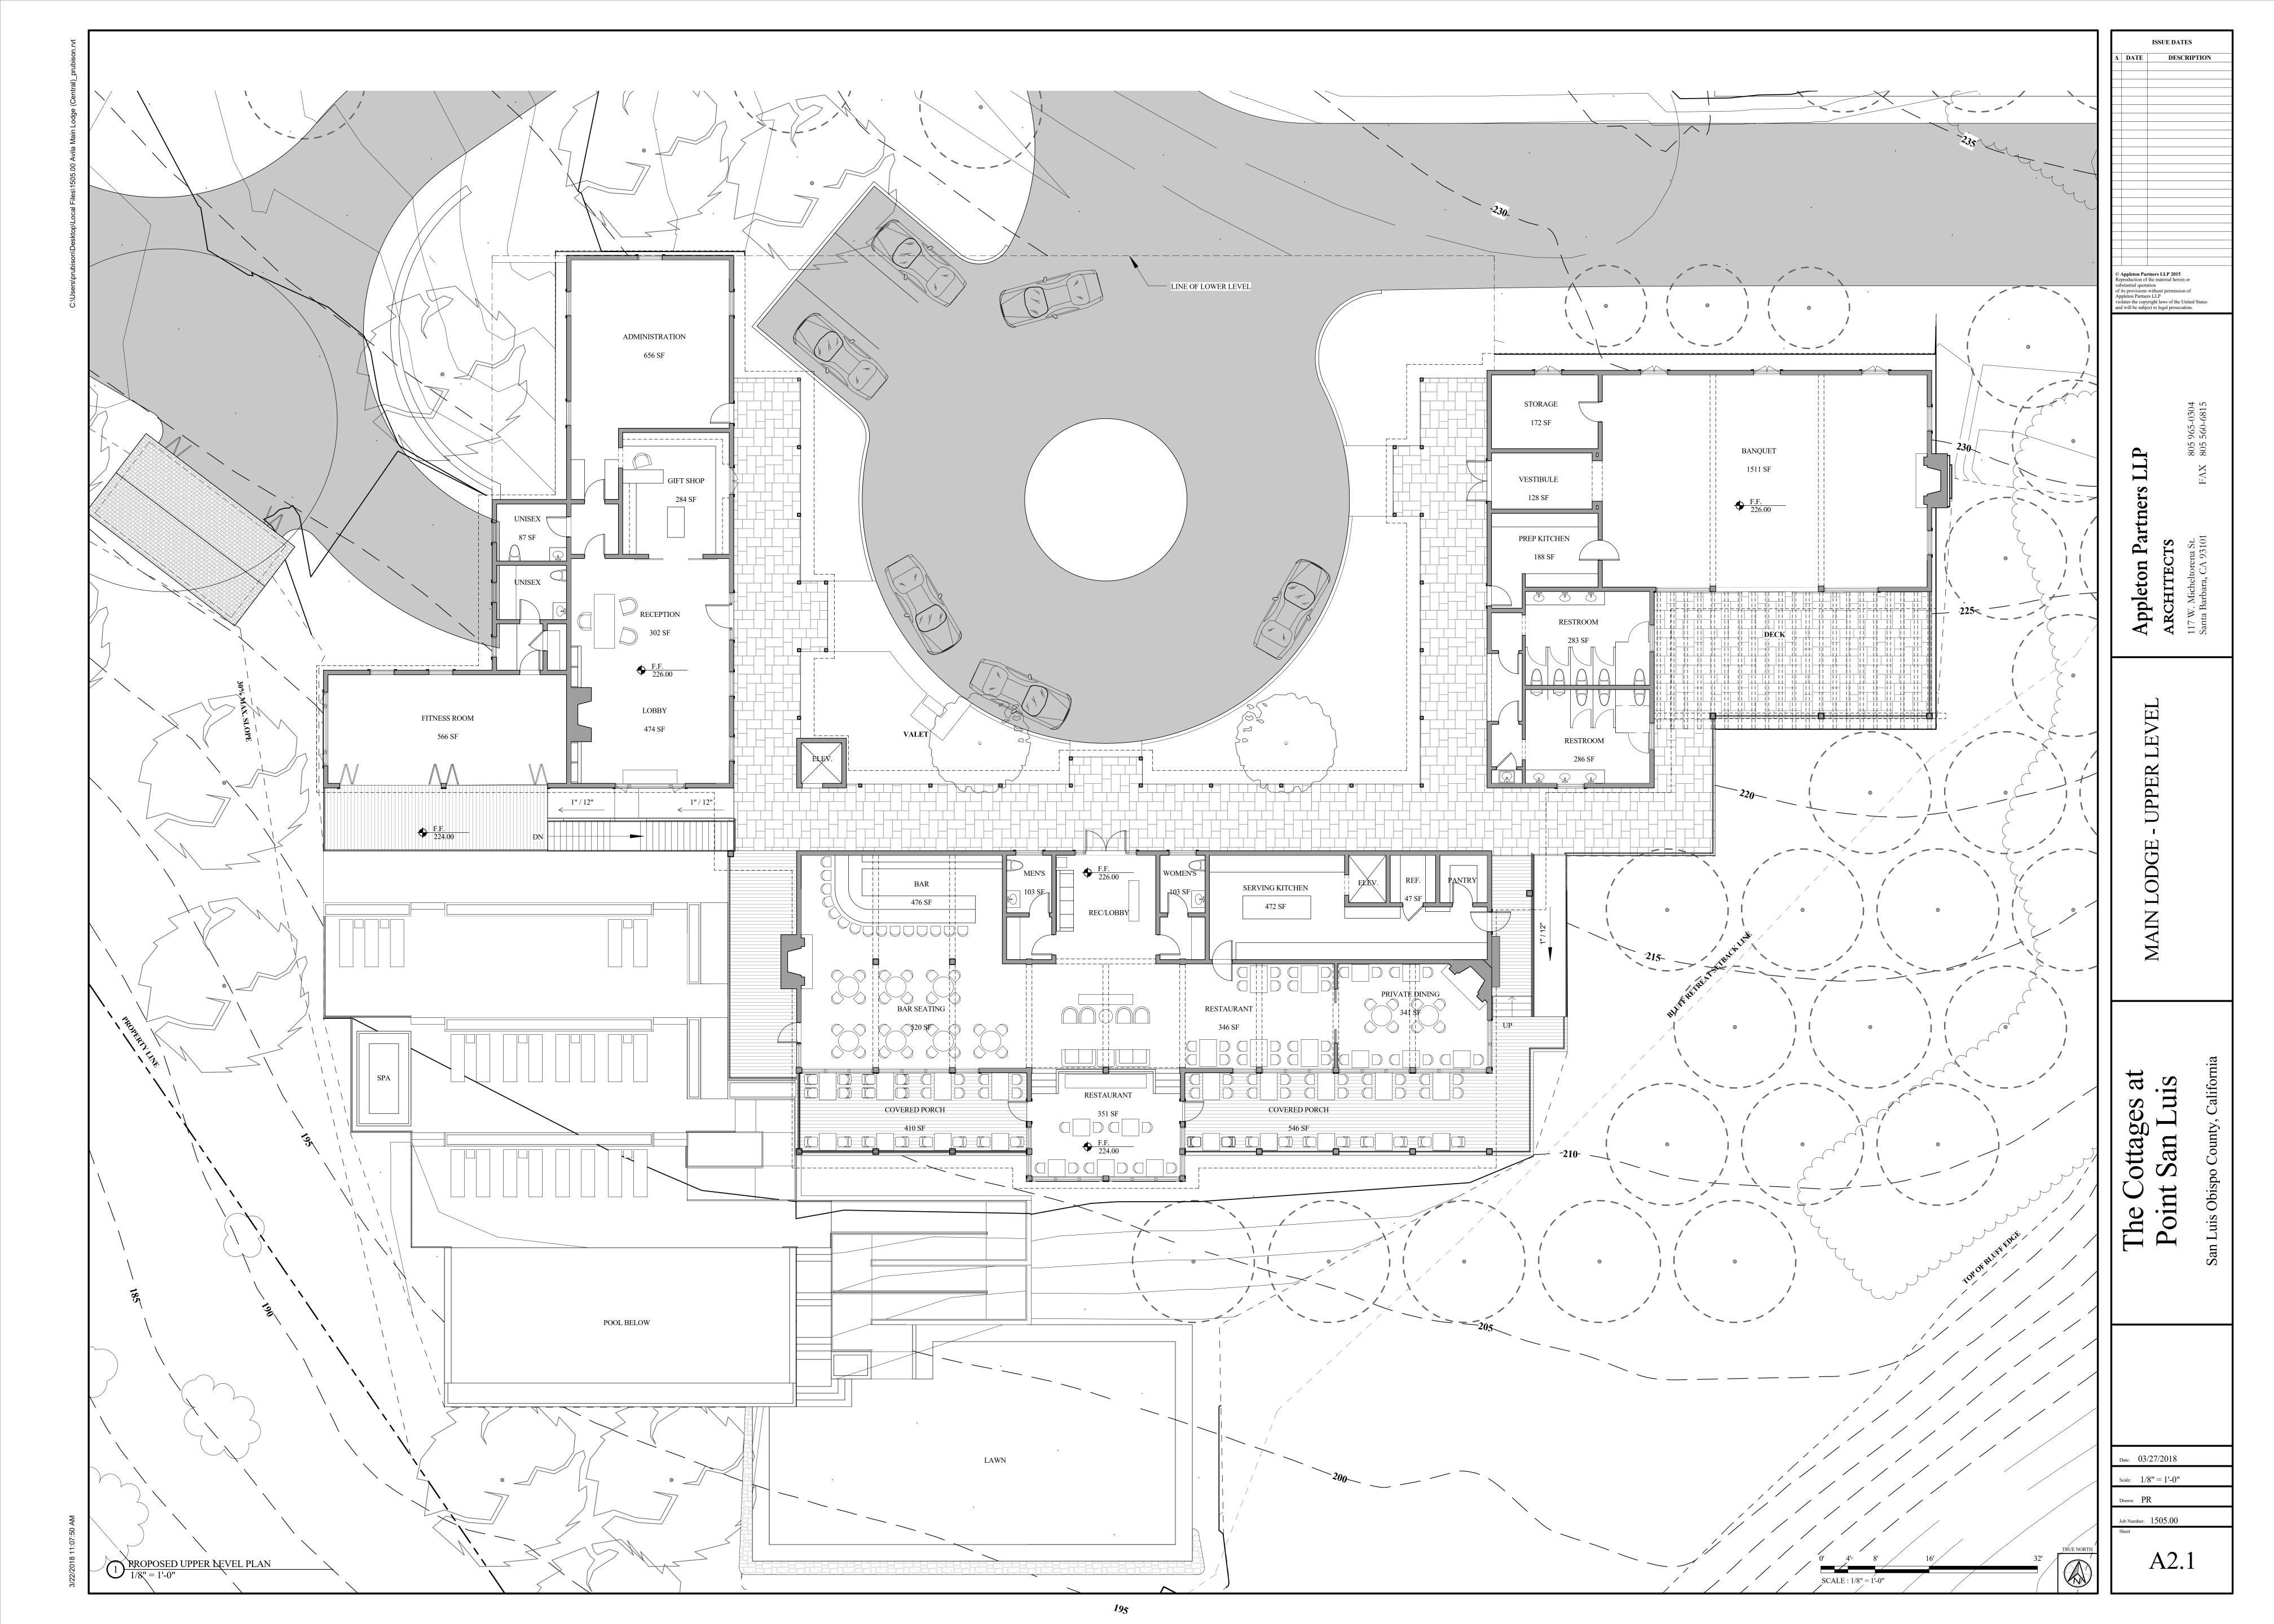


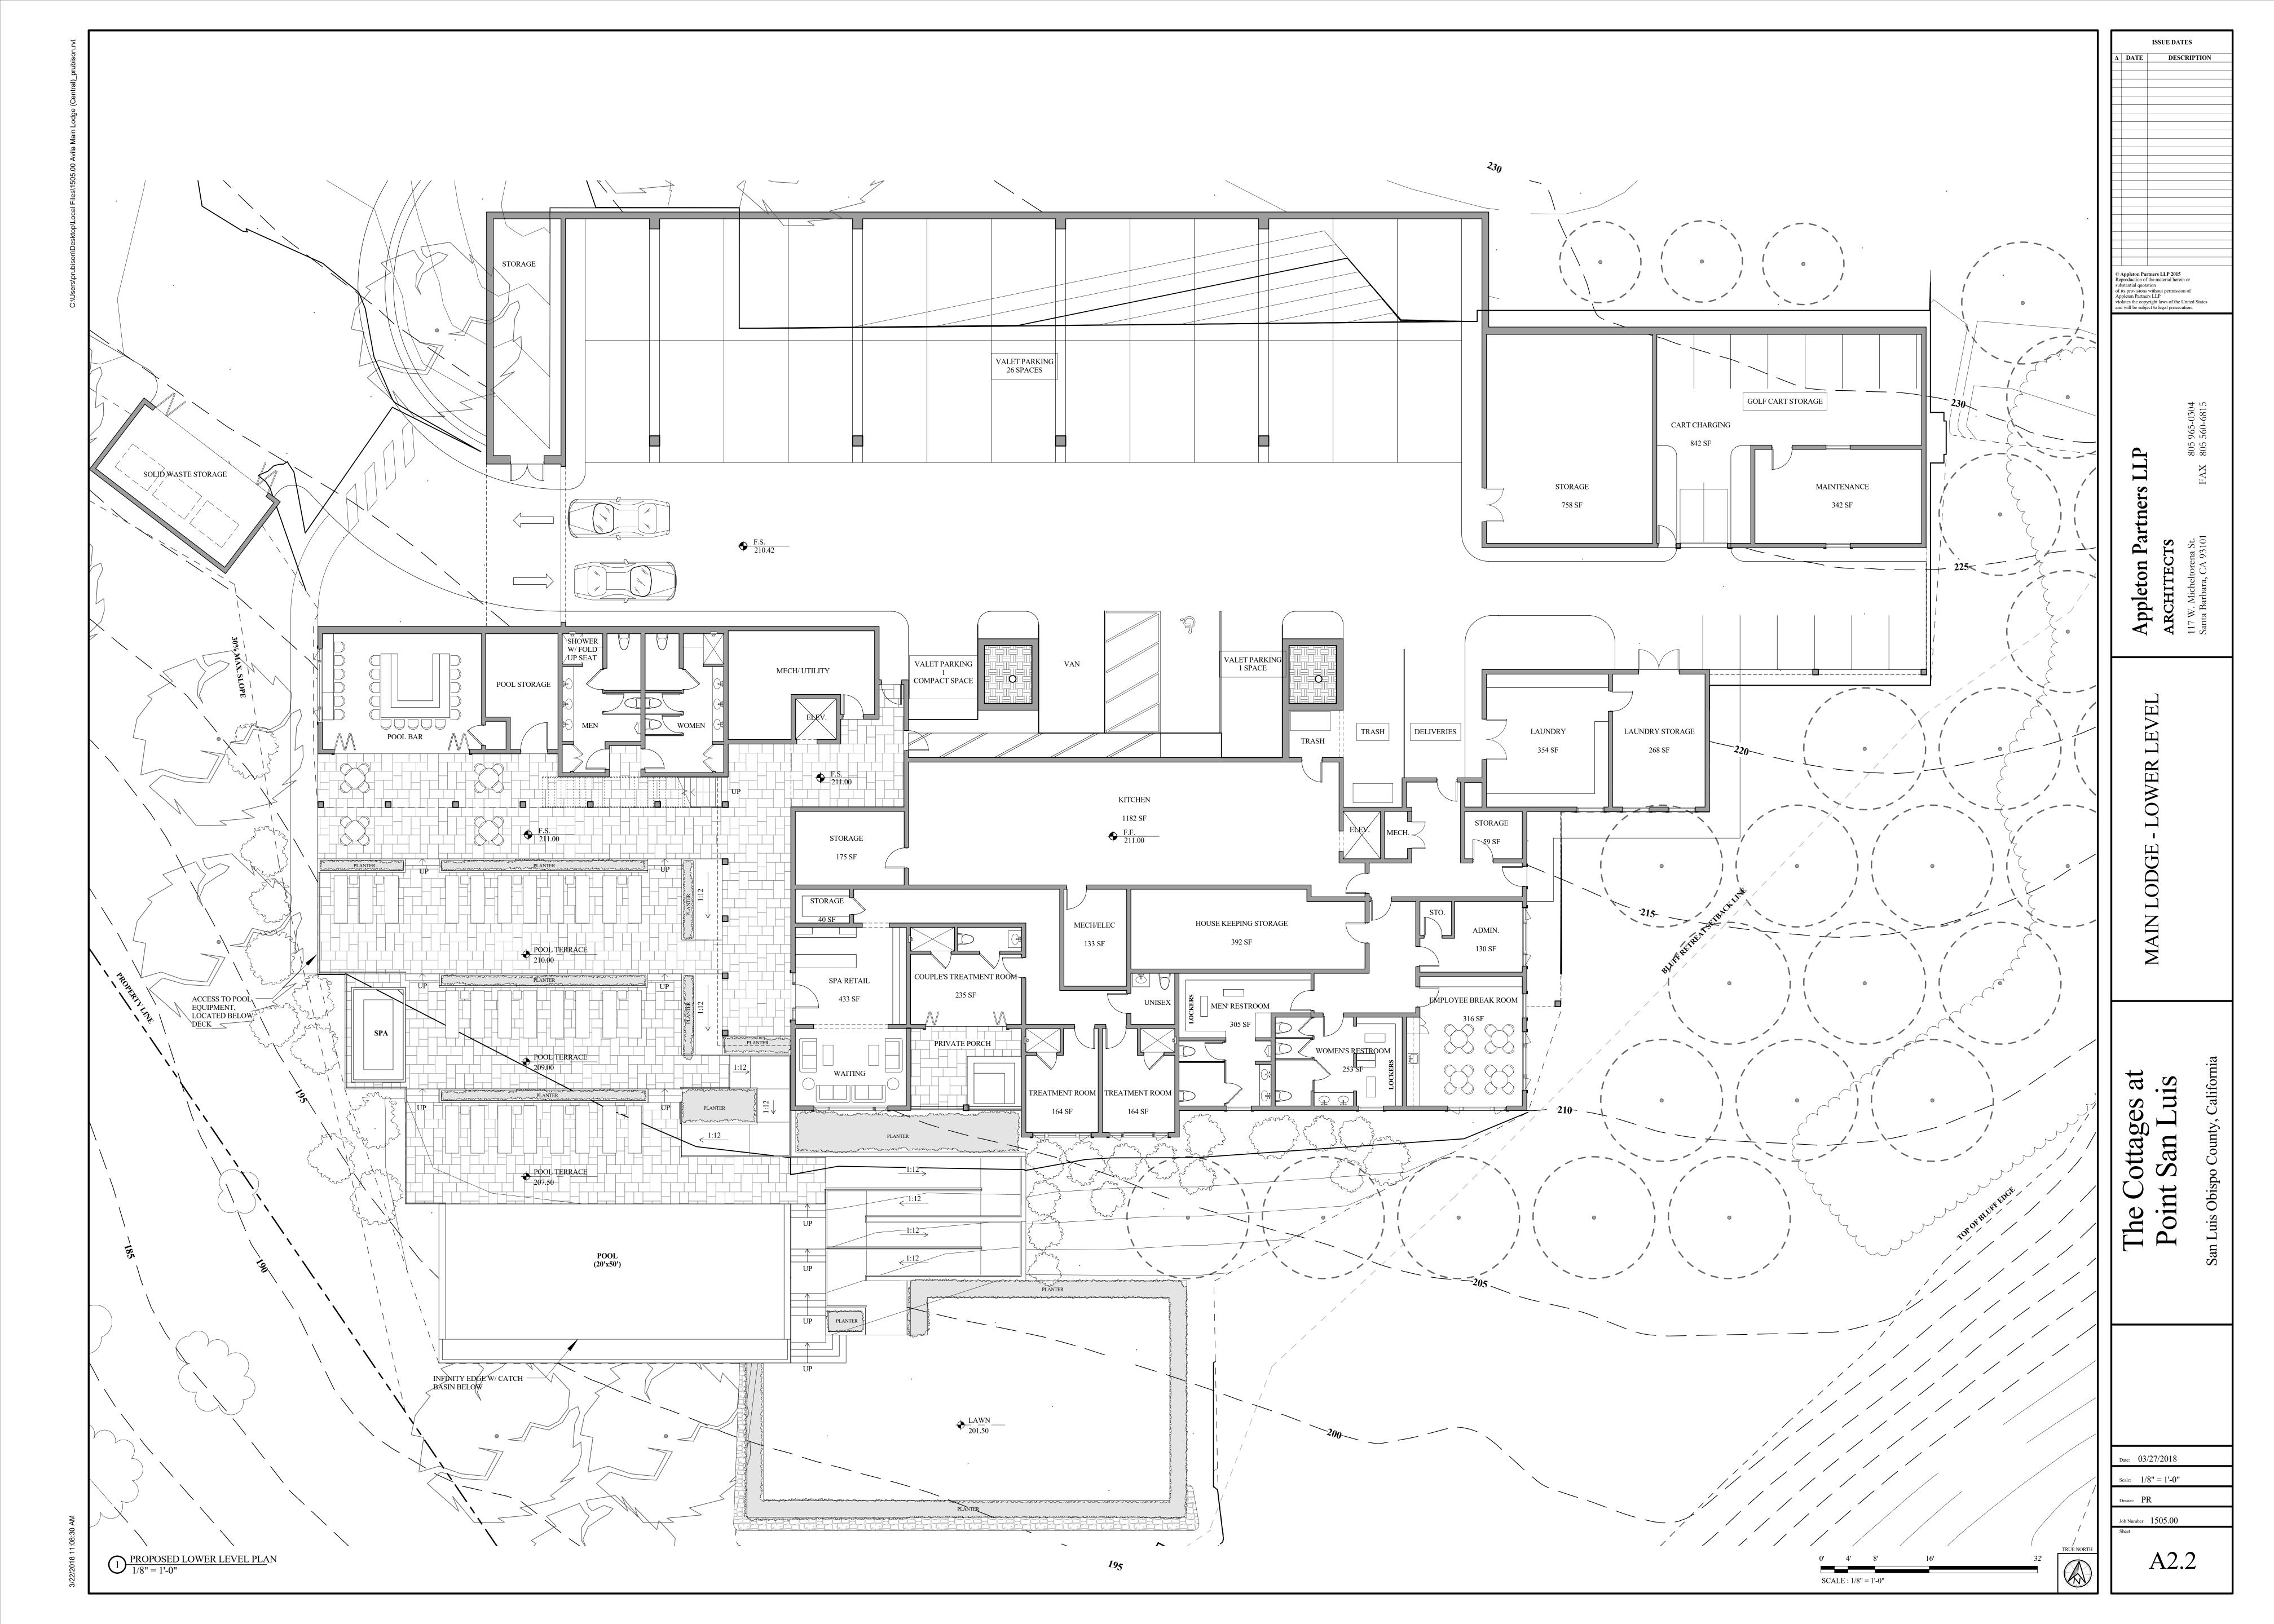

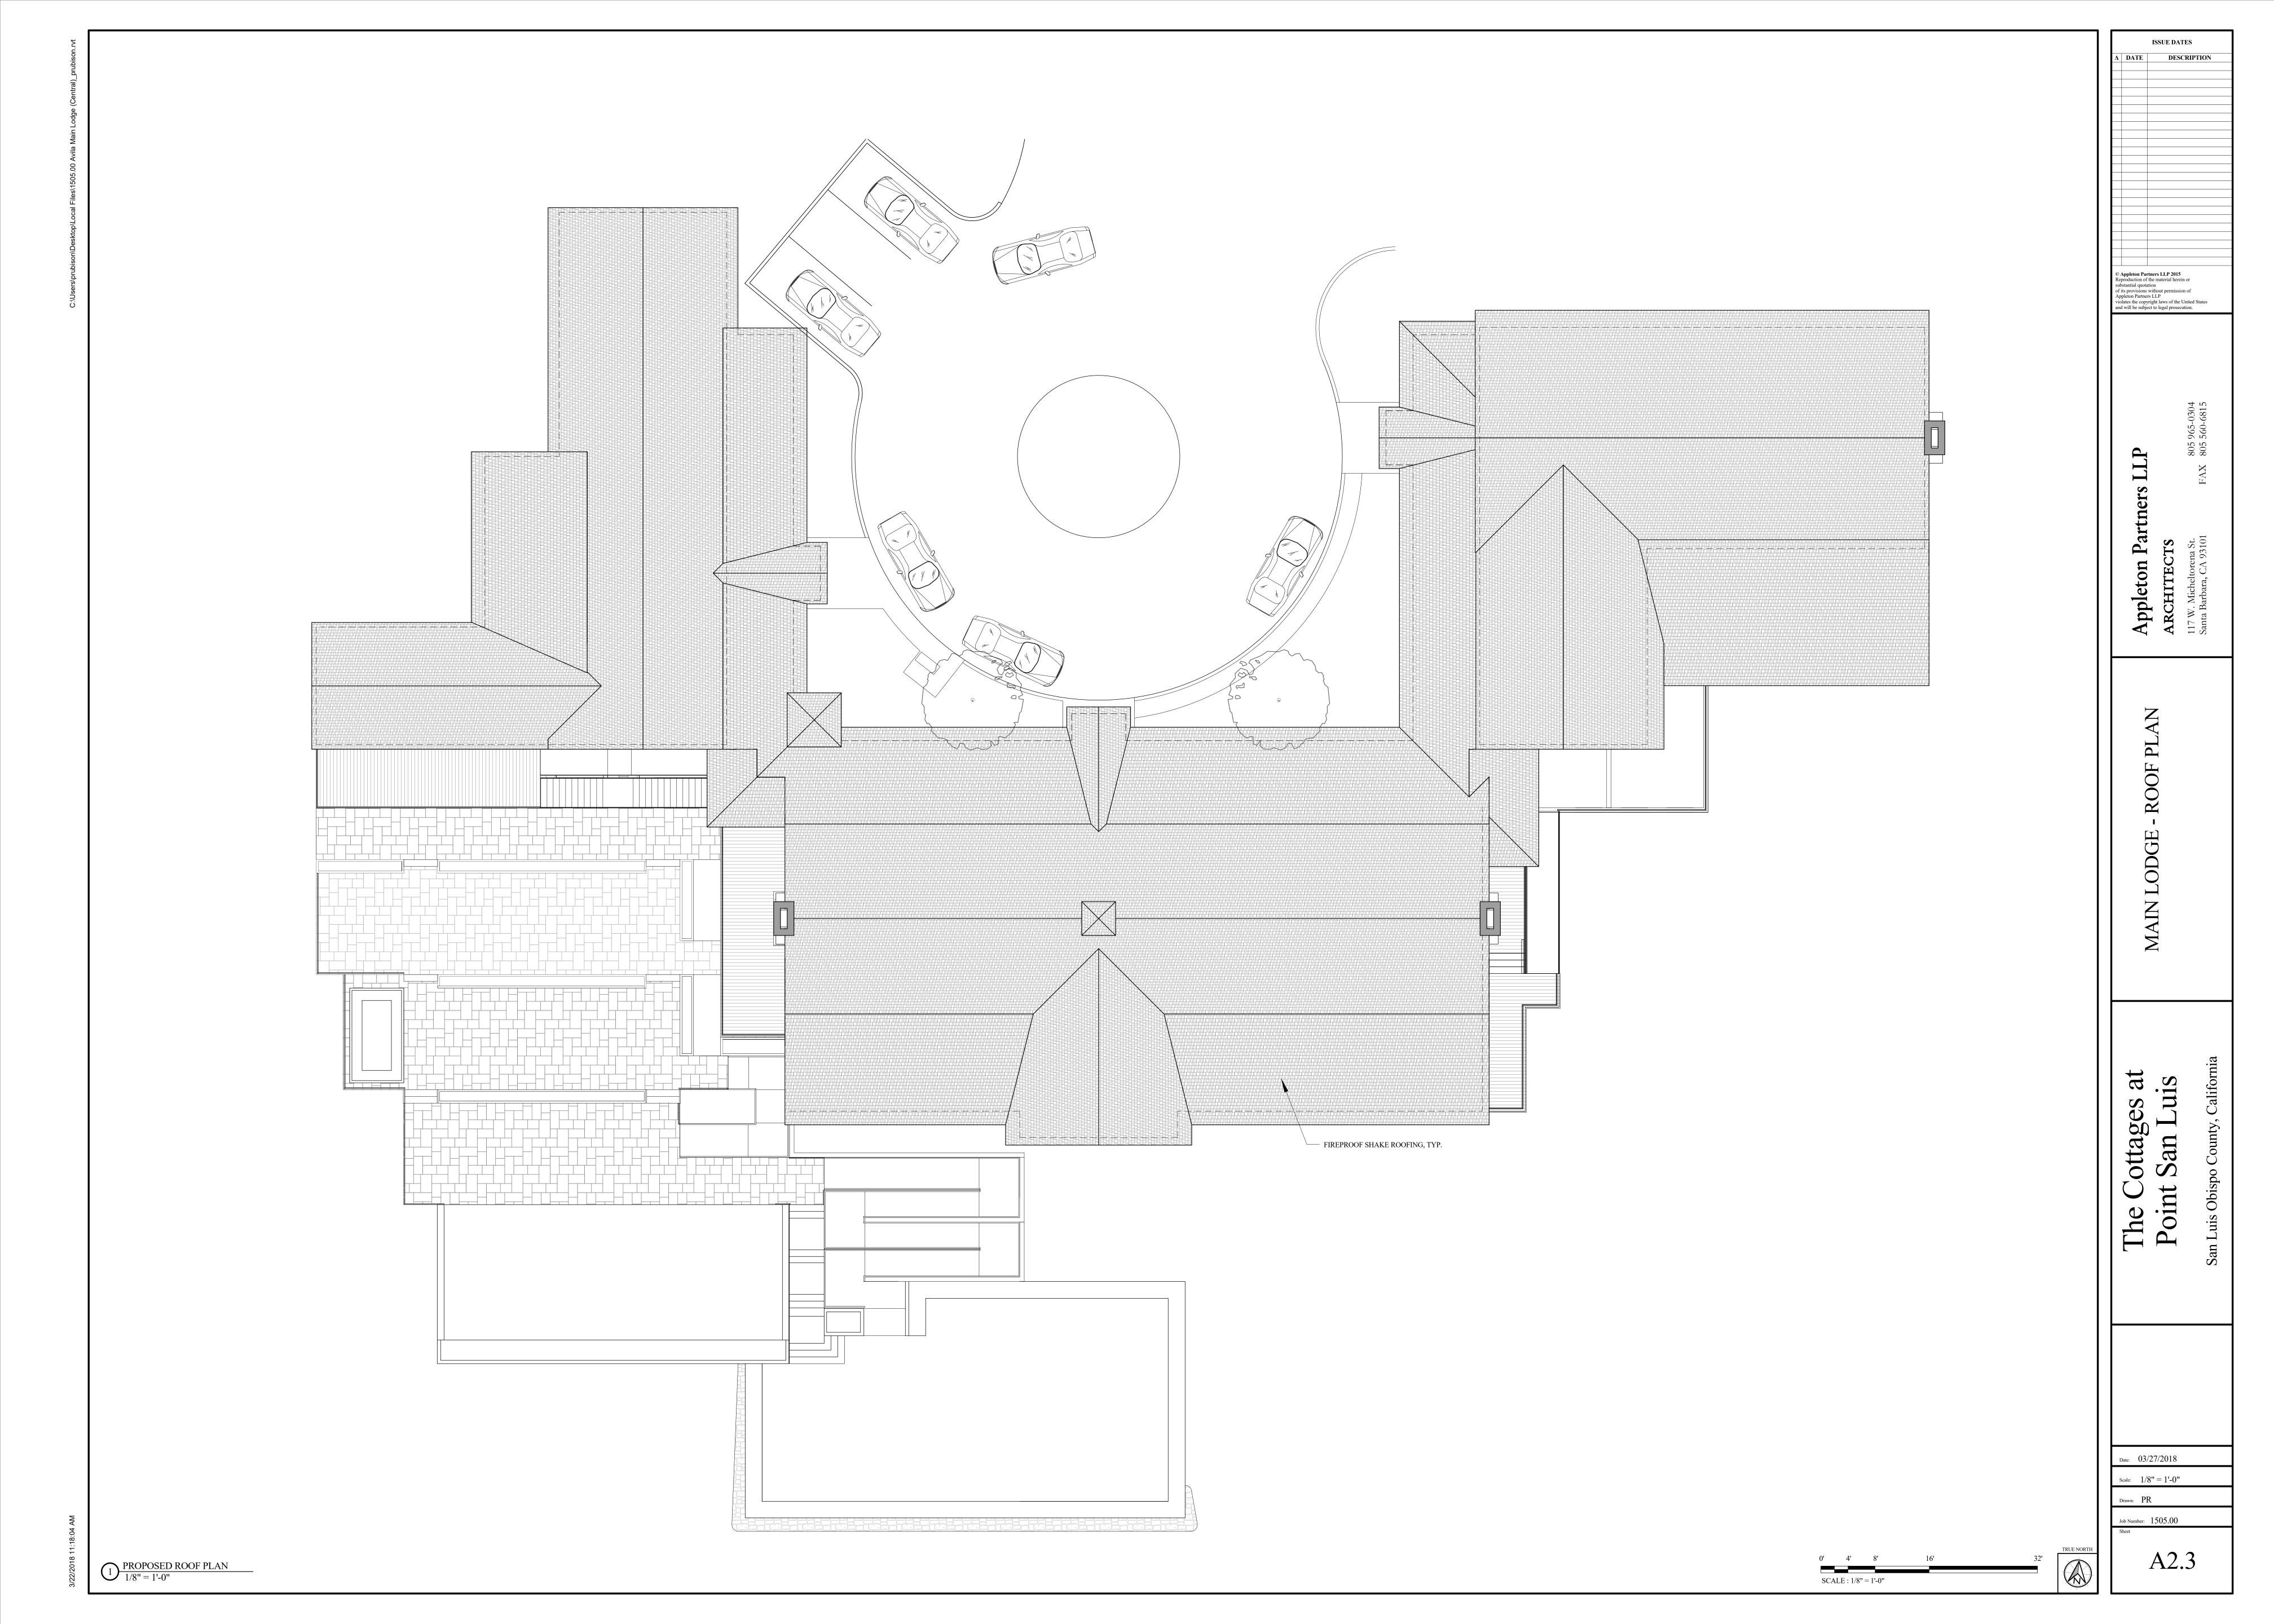


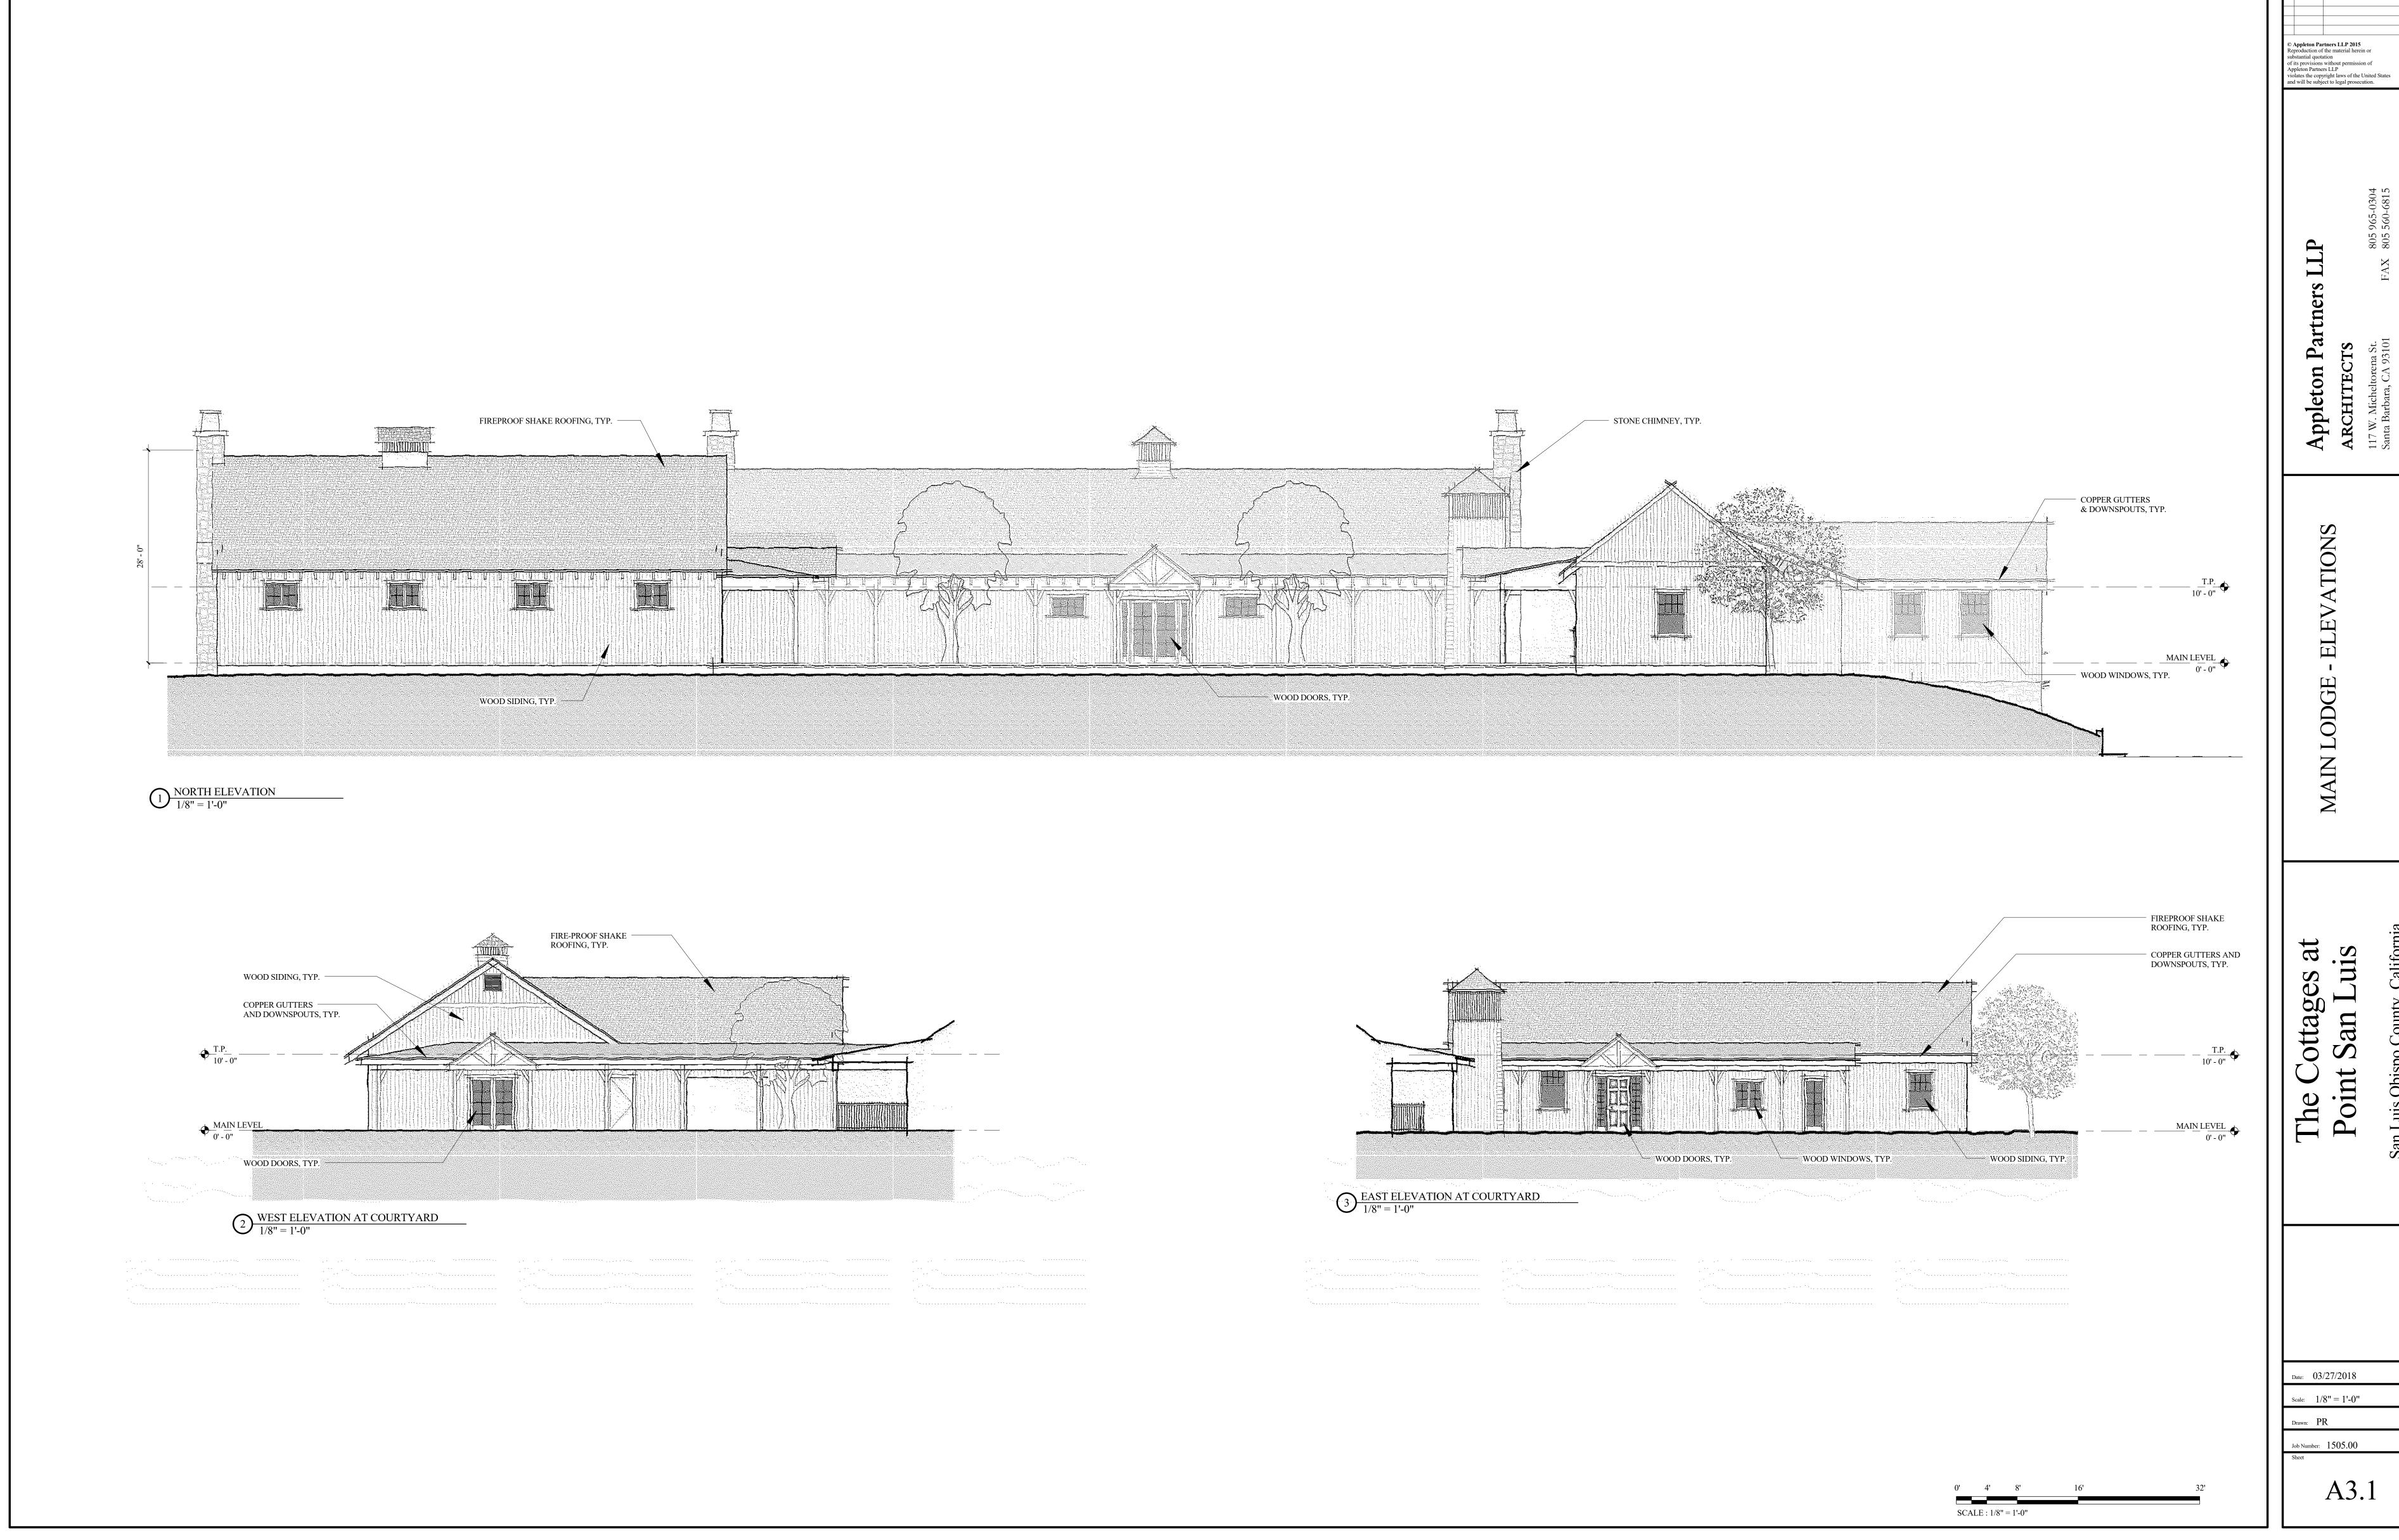



Δ DATE DESCRIPTION

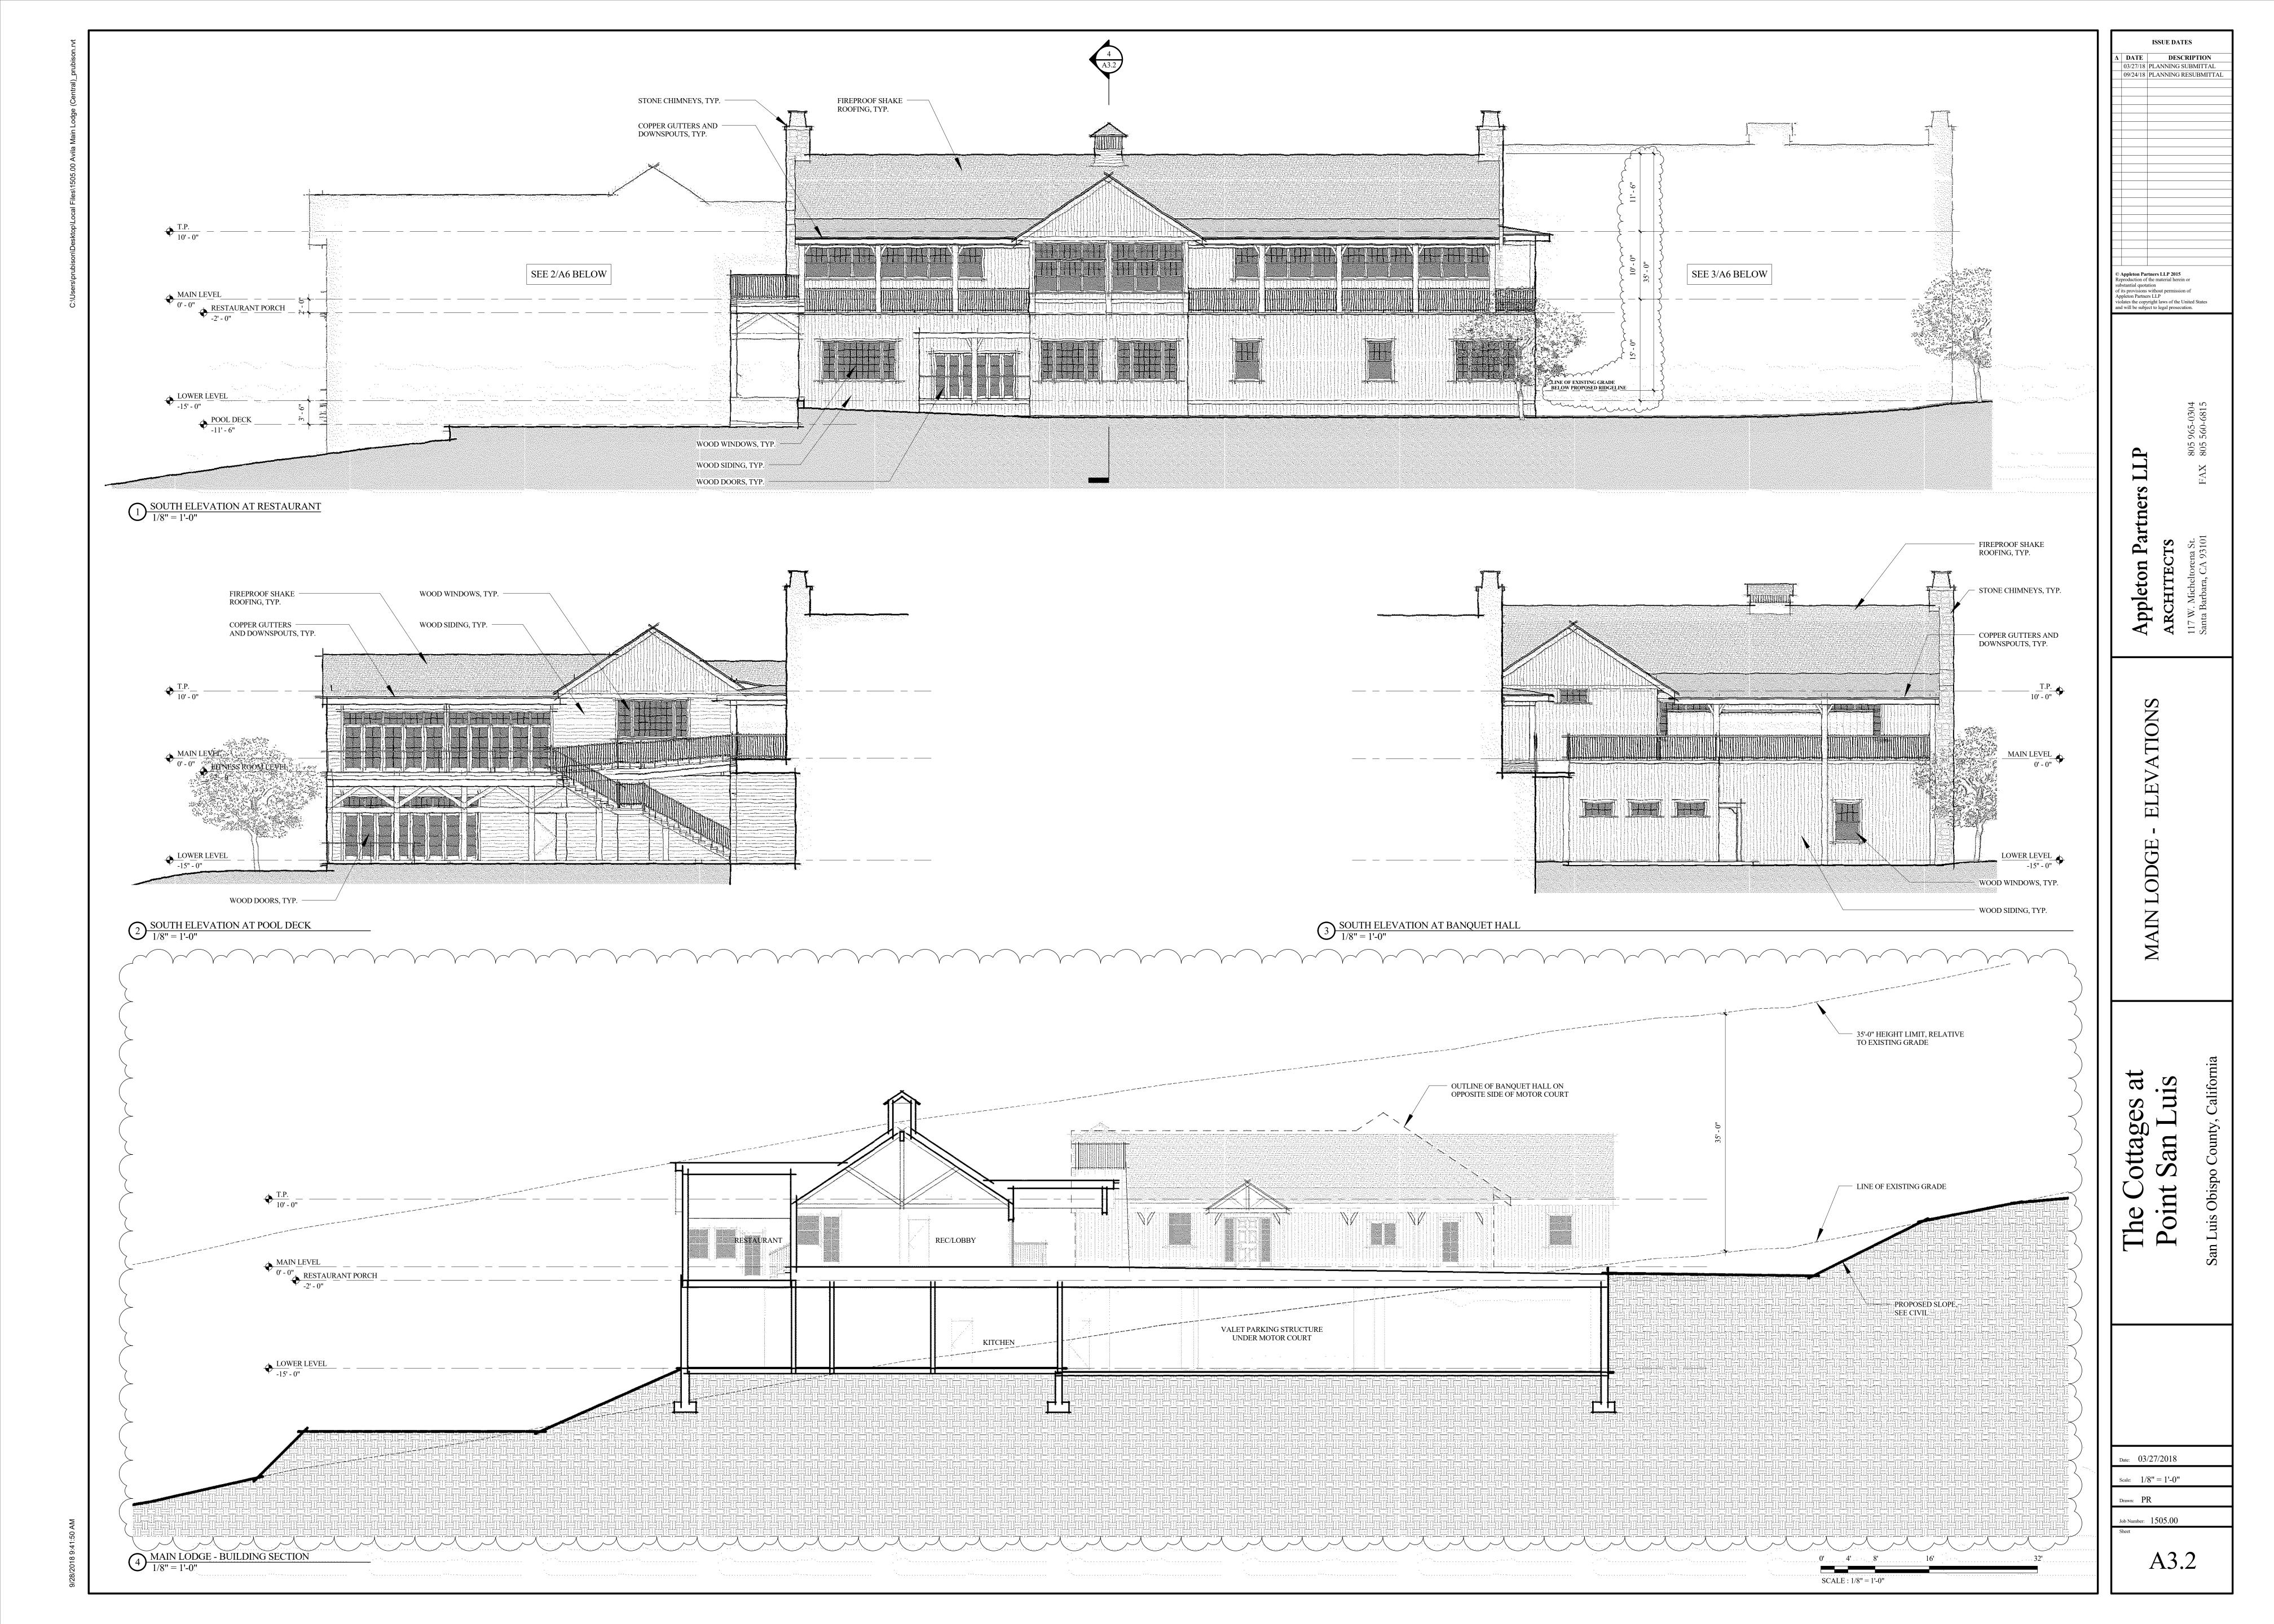



# COTTAGE TYPE "A" FIREPROOF SHAKE ROOFING, TYP.

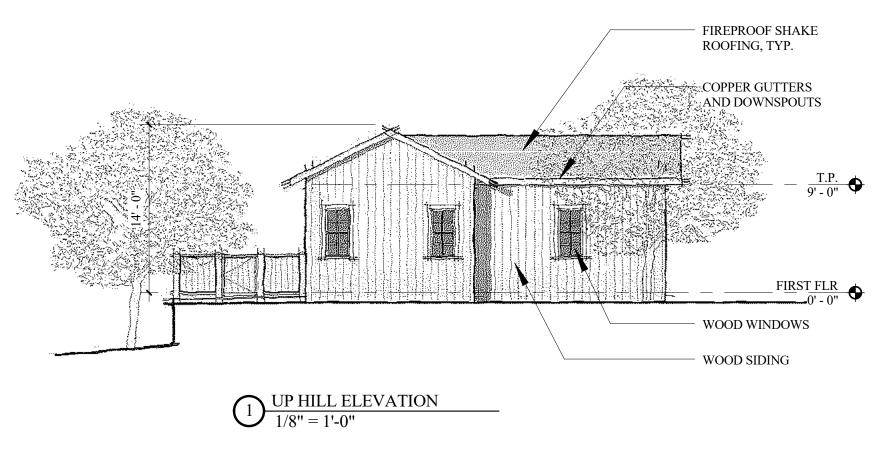


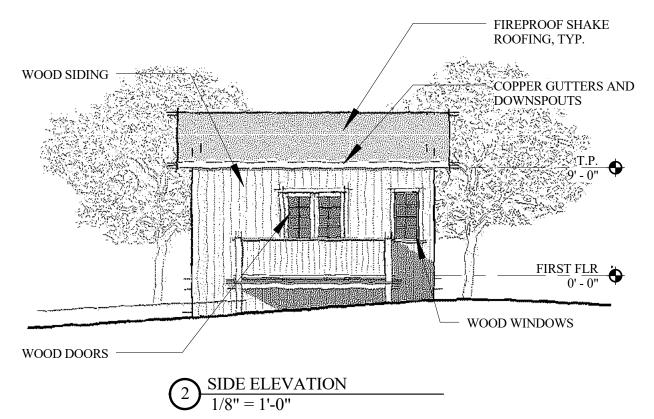

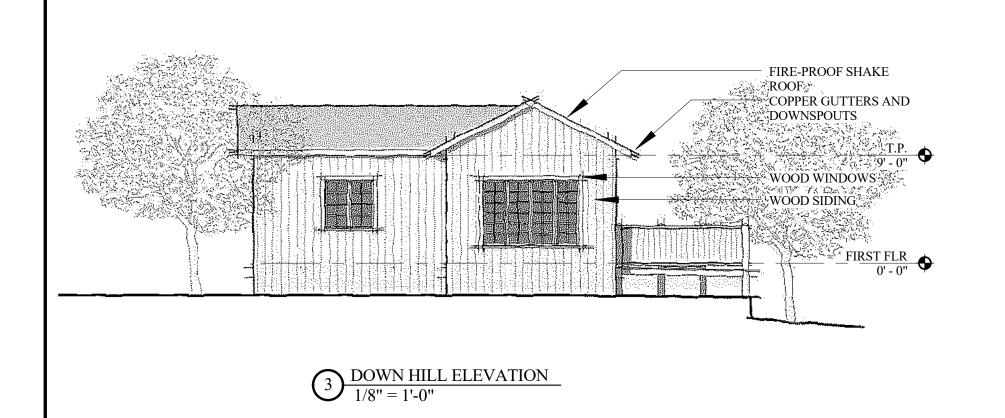


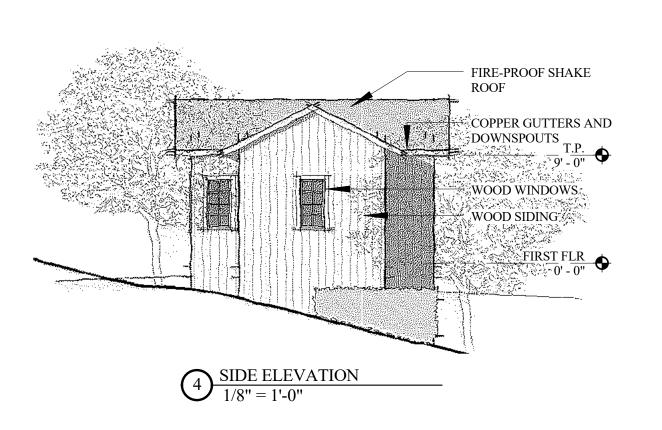


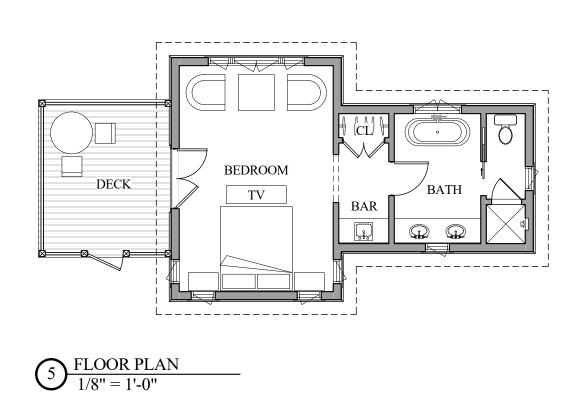


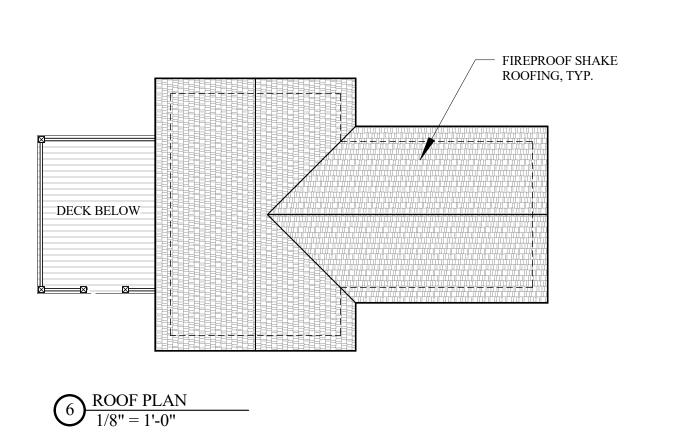



## COTTAGE TYPE "B"

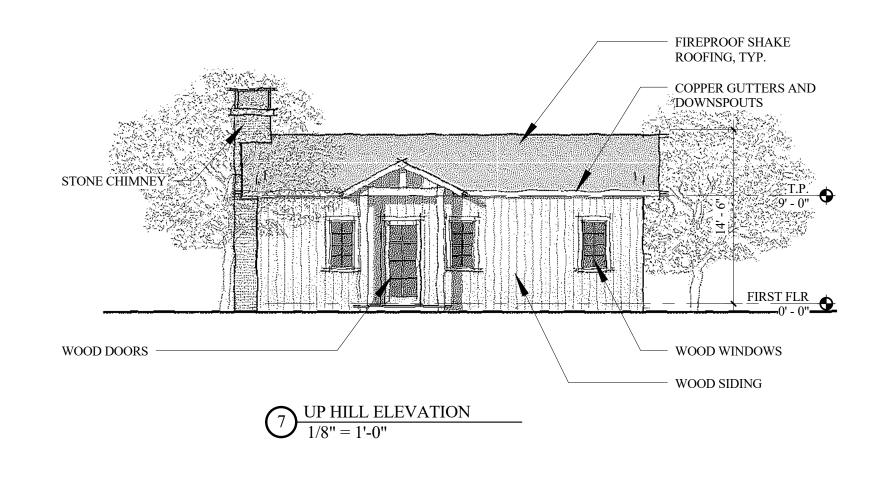


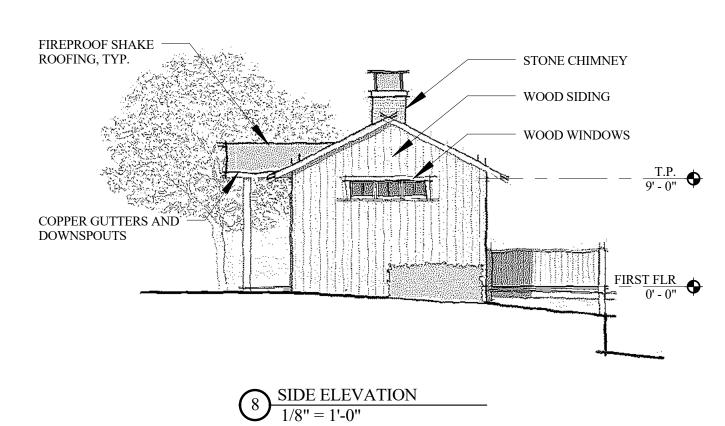

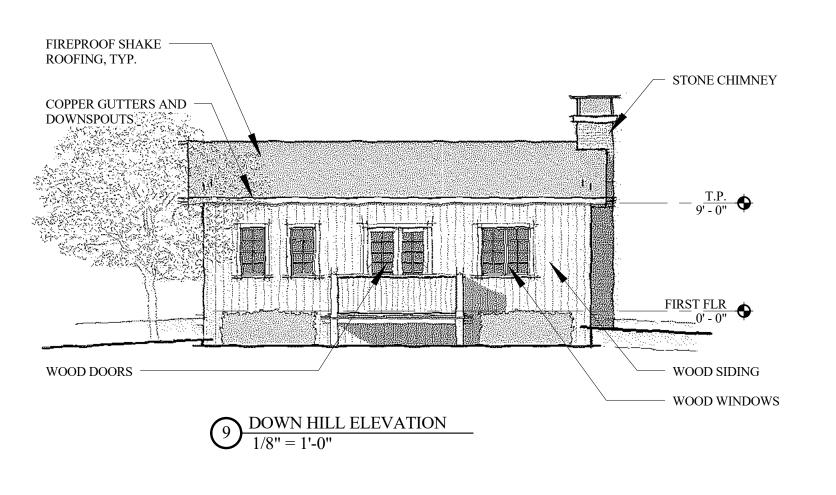

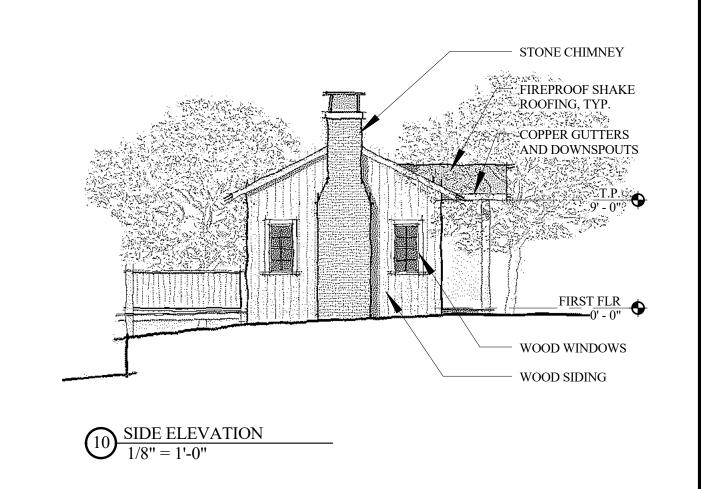

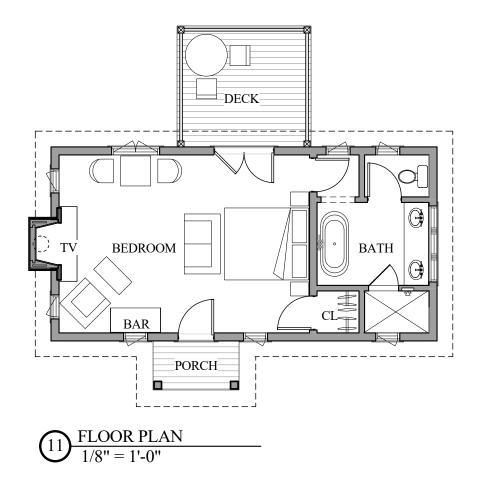

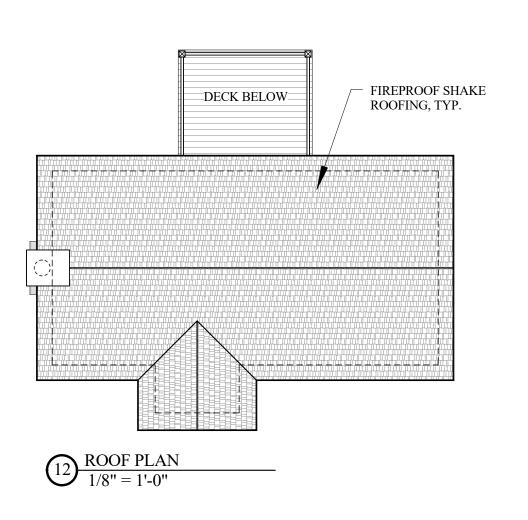



ISSUE DATES				
Δ	DATE	DESCRIPTION		
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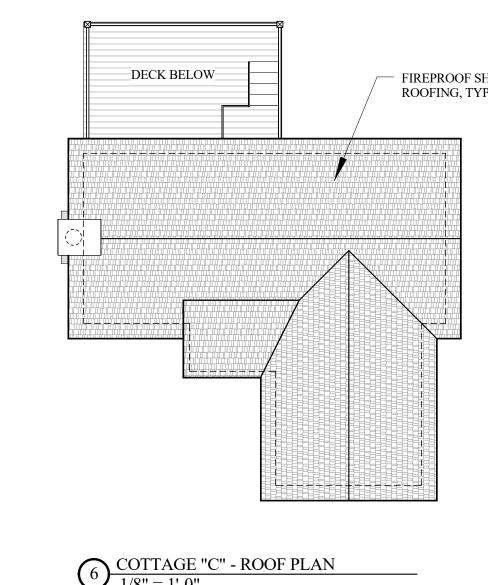
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 $\begin{array}{c}
1 & \text{DOWN HILL ELEVATION} \\
\hline
1/8" = 1'-0"
\end{array}$ 


WOOD DOORS







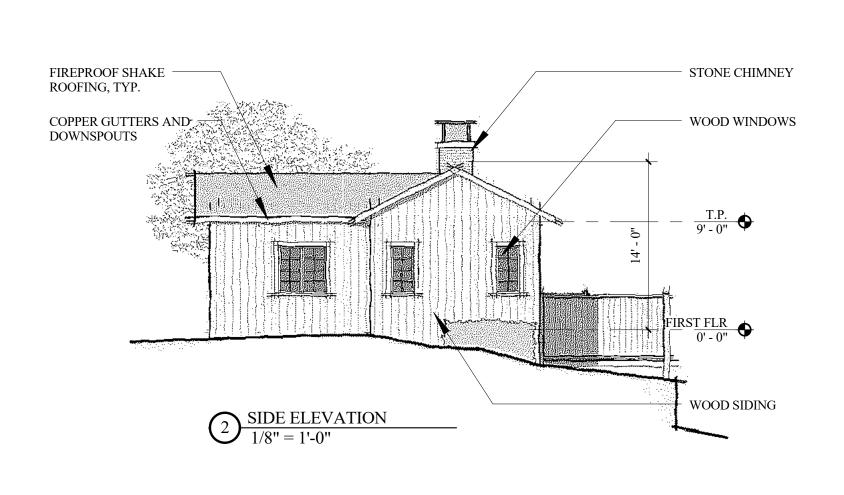


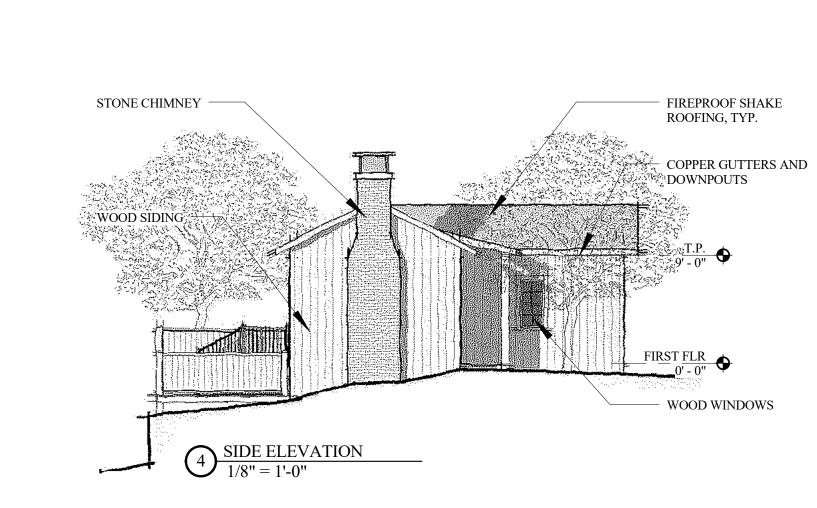
## COTTAGE TYPE "D"

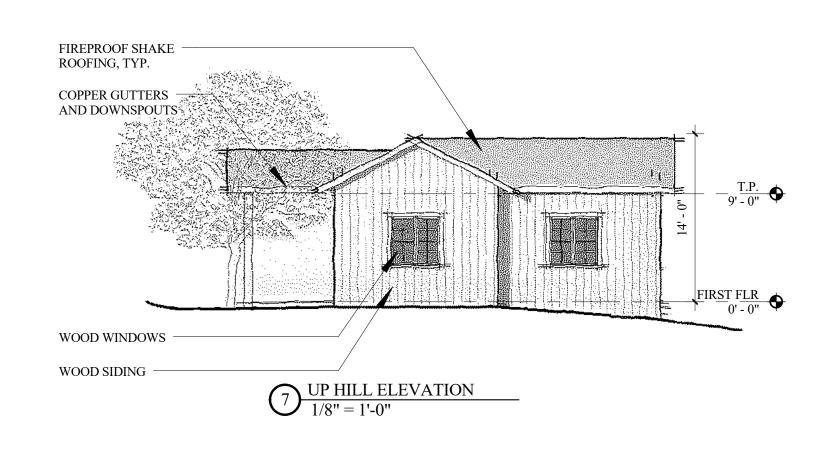


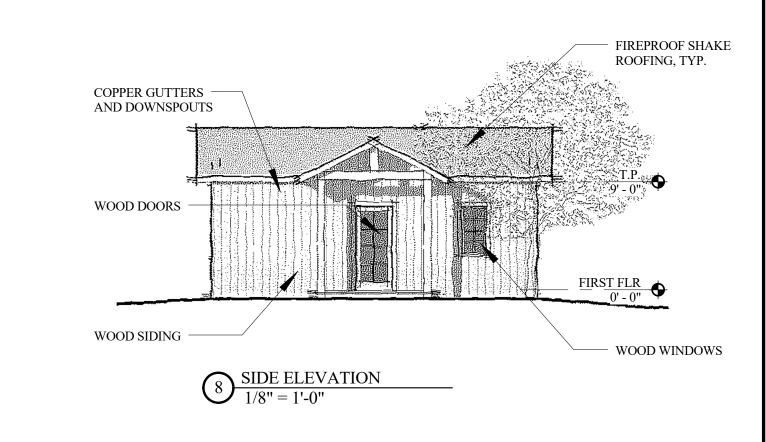


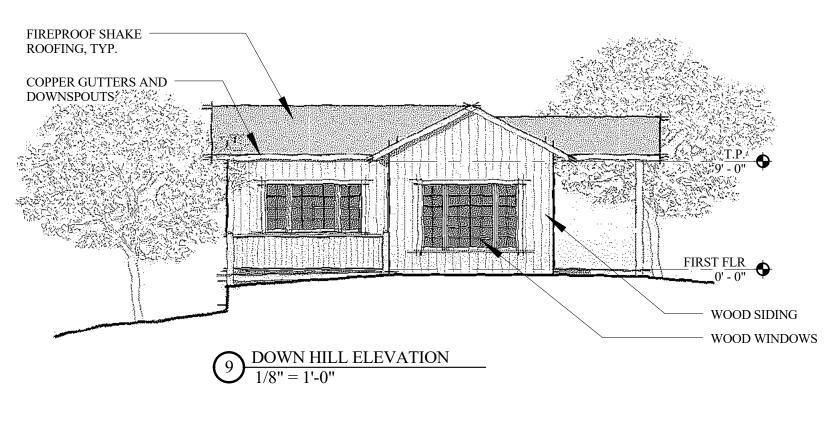

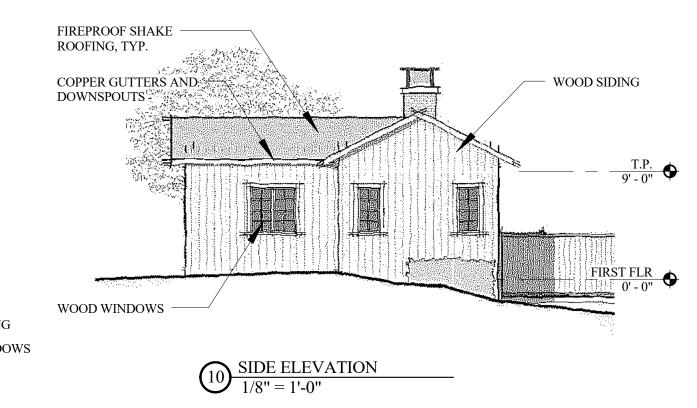

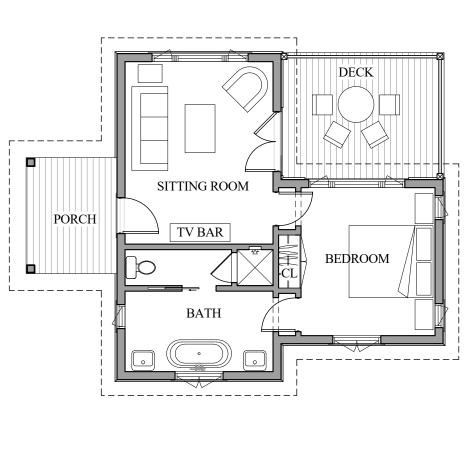

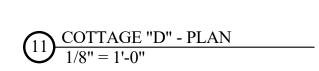

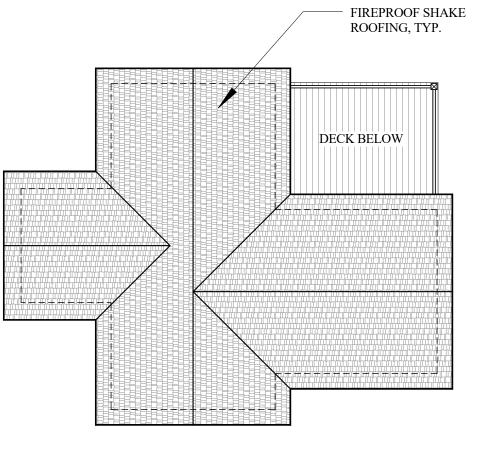


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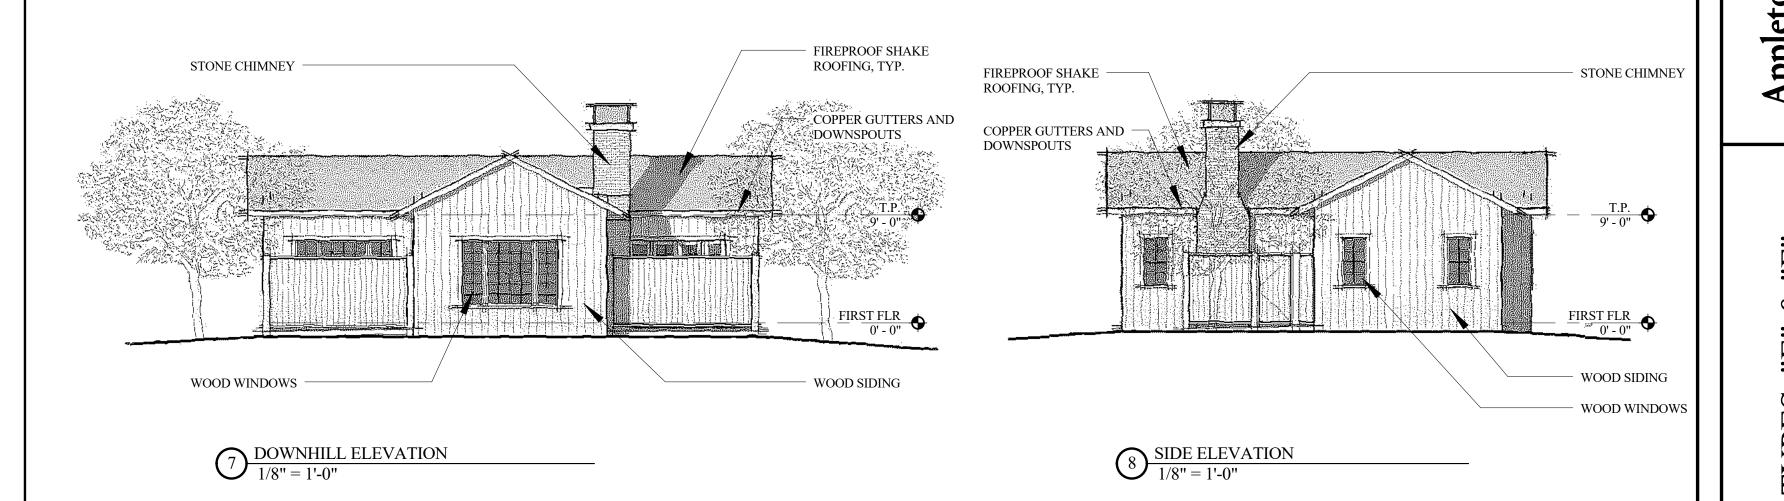
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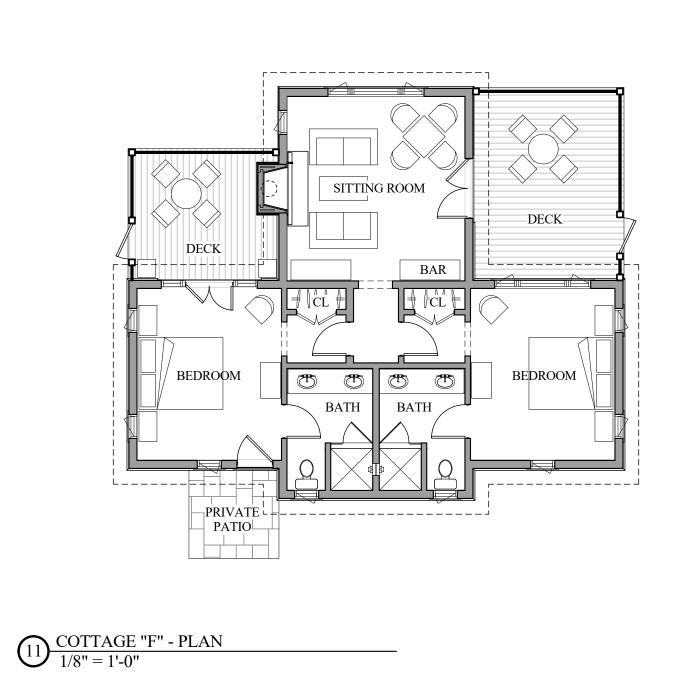
FIREPROOF SHAKE - ROOFING, TYP. WOOD SIDING STONE CHIMNEY —— COPPER GUTTERS AND — DOWNSPOUTS WOOD WINDOWS WOOD DOORS 3 UP HILL ELEVATION 1/8" = 1'-0"


FIREPROOF SHAKE ROOFING, TYP.

## COTTAGE TYPE "F"






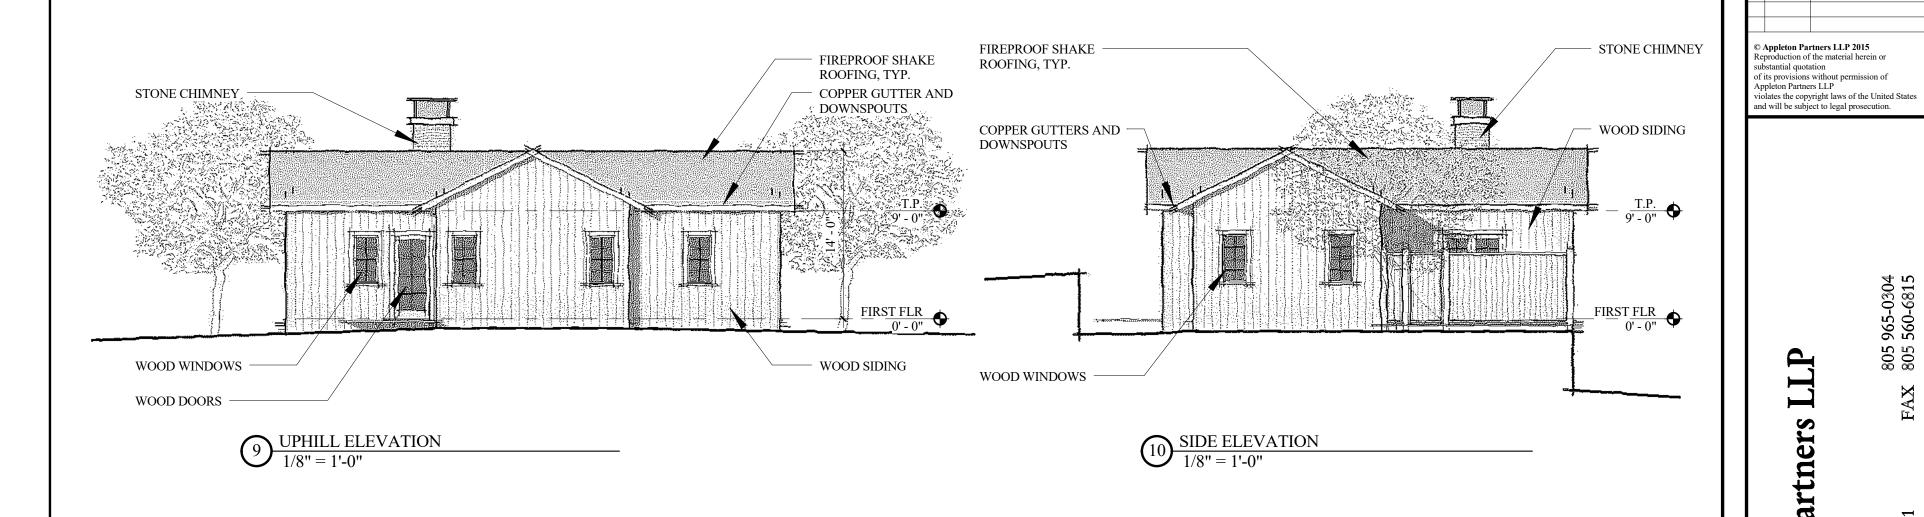

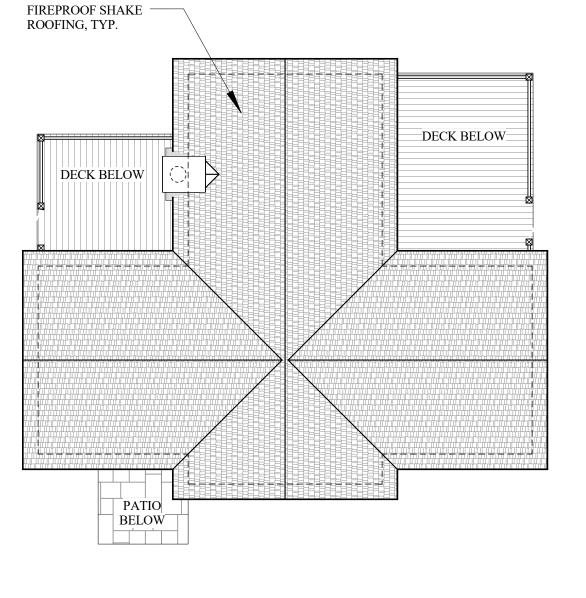

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**CRITICAL VIEWS KEY MAP** 

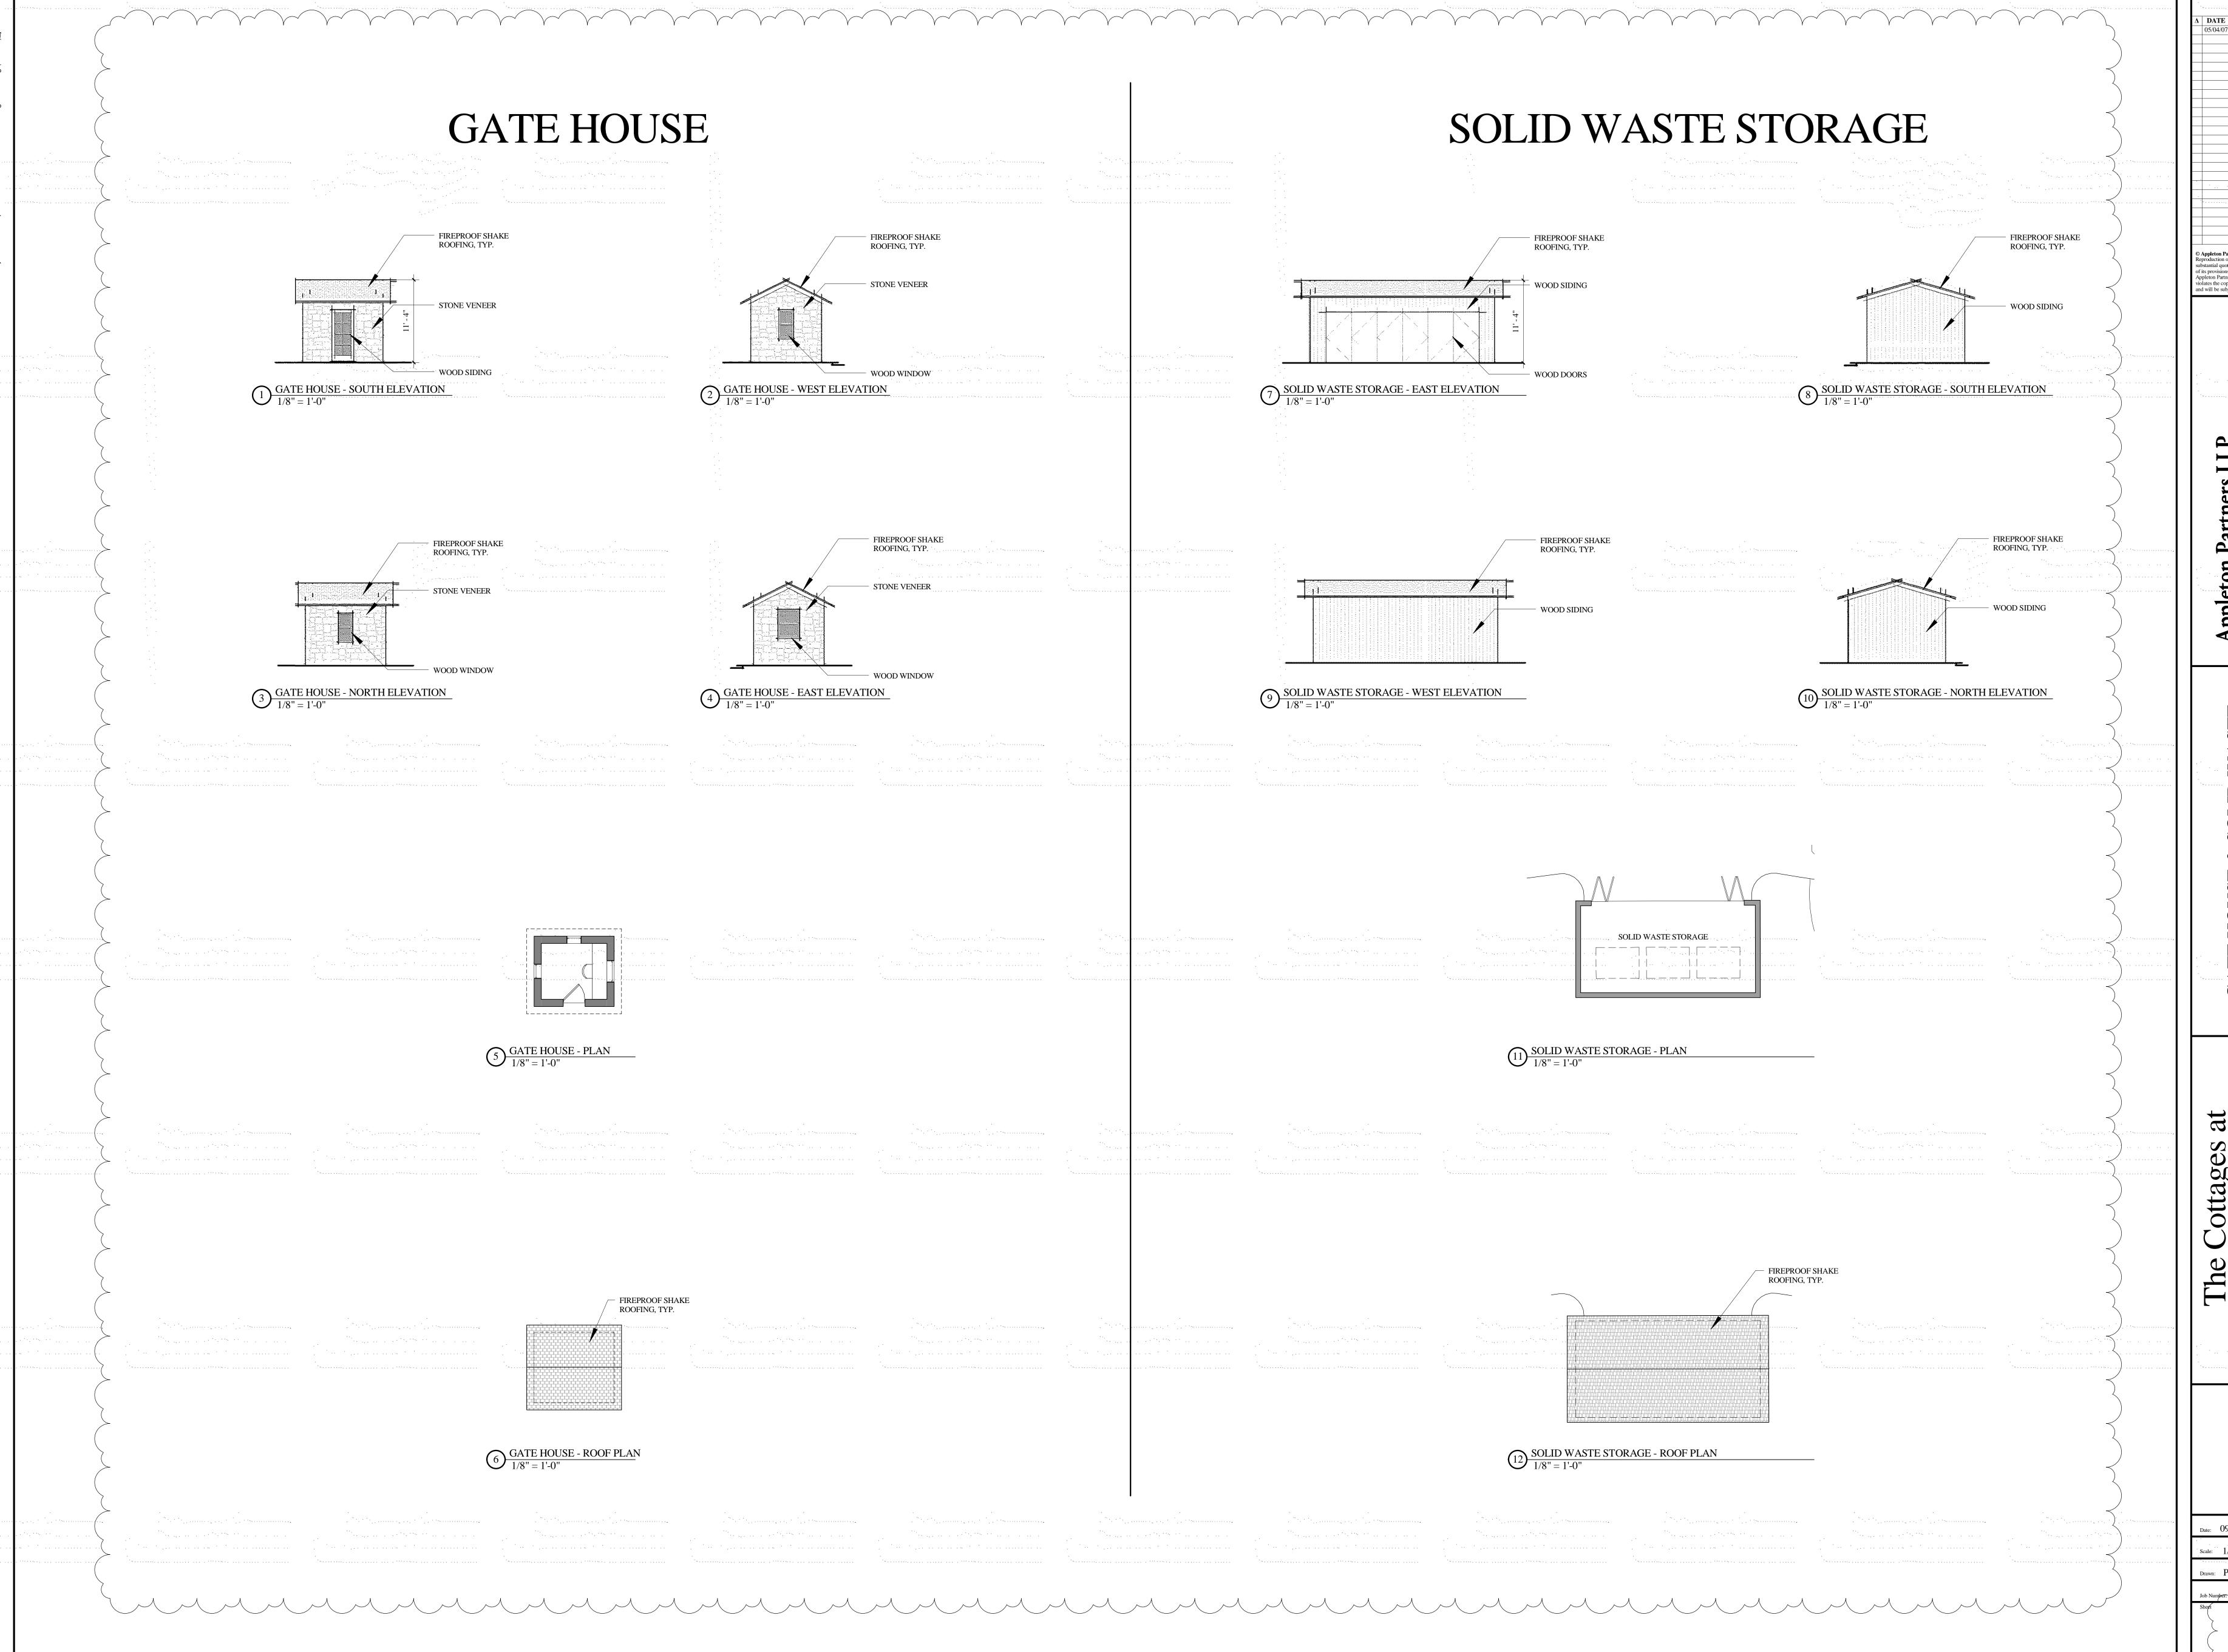


VIEW 1 FROM 101 FWY



VIEW (2) FROM AVILA BEACH CITY BEACH



VIEW (3) FROM AVILA BEACH DRIVE AND PARK

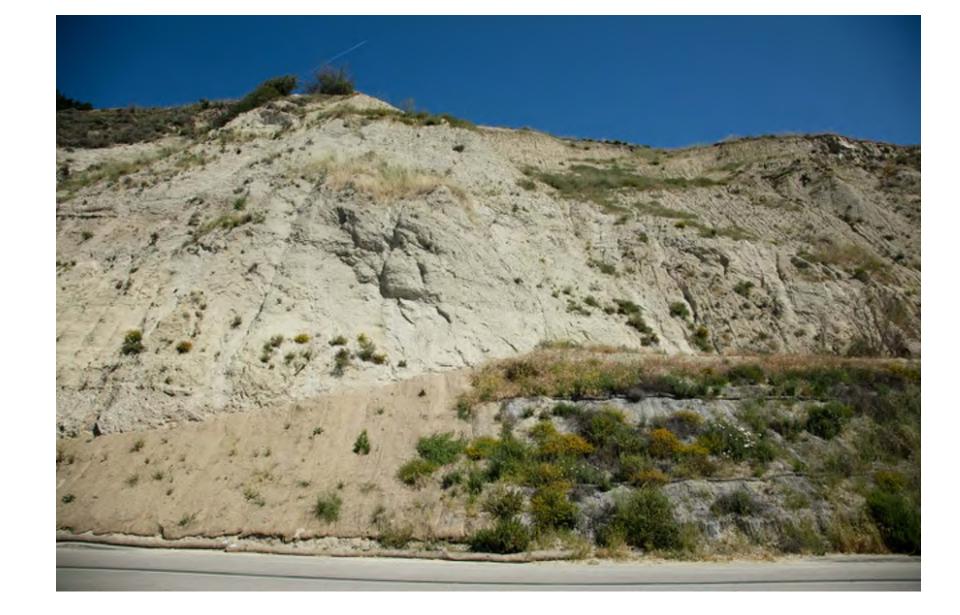

VIEW 4 FROM AVILA BEACH DRIVE, SOUTH OF SITE (SITE ABOVE NOT VISIBLE IN THIS VIEW)



VIEW 5 FROM OLDE PORT BEACH


The Cottages
Point San Lu

ale: 03/27/2018

Drawn: **MW**Job Number: 1505.00

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2/2018 10:36:02 AM

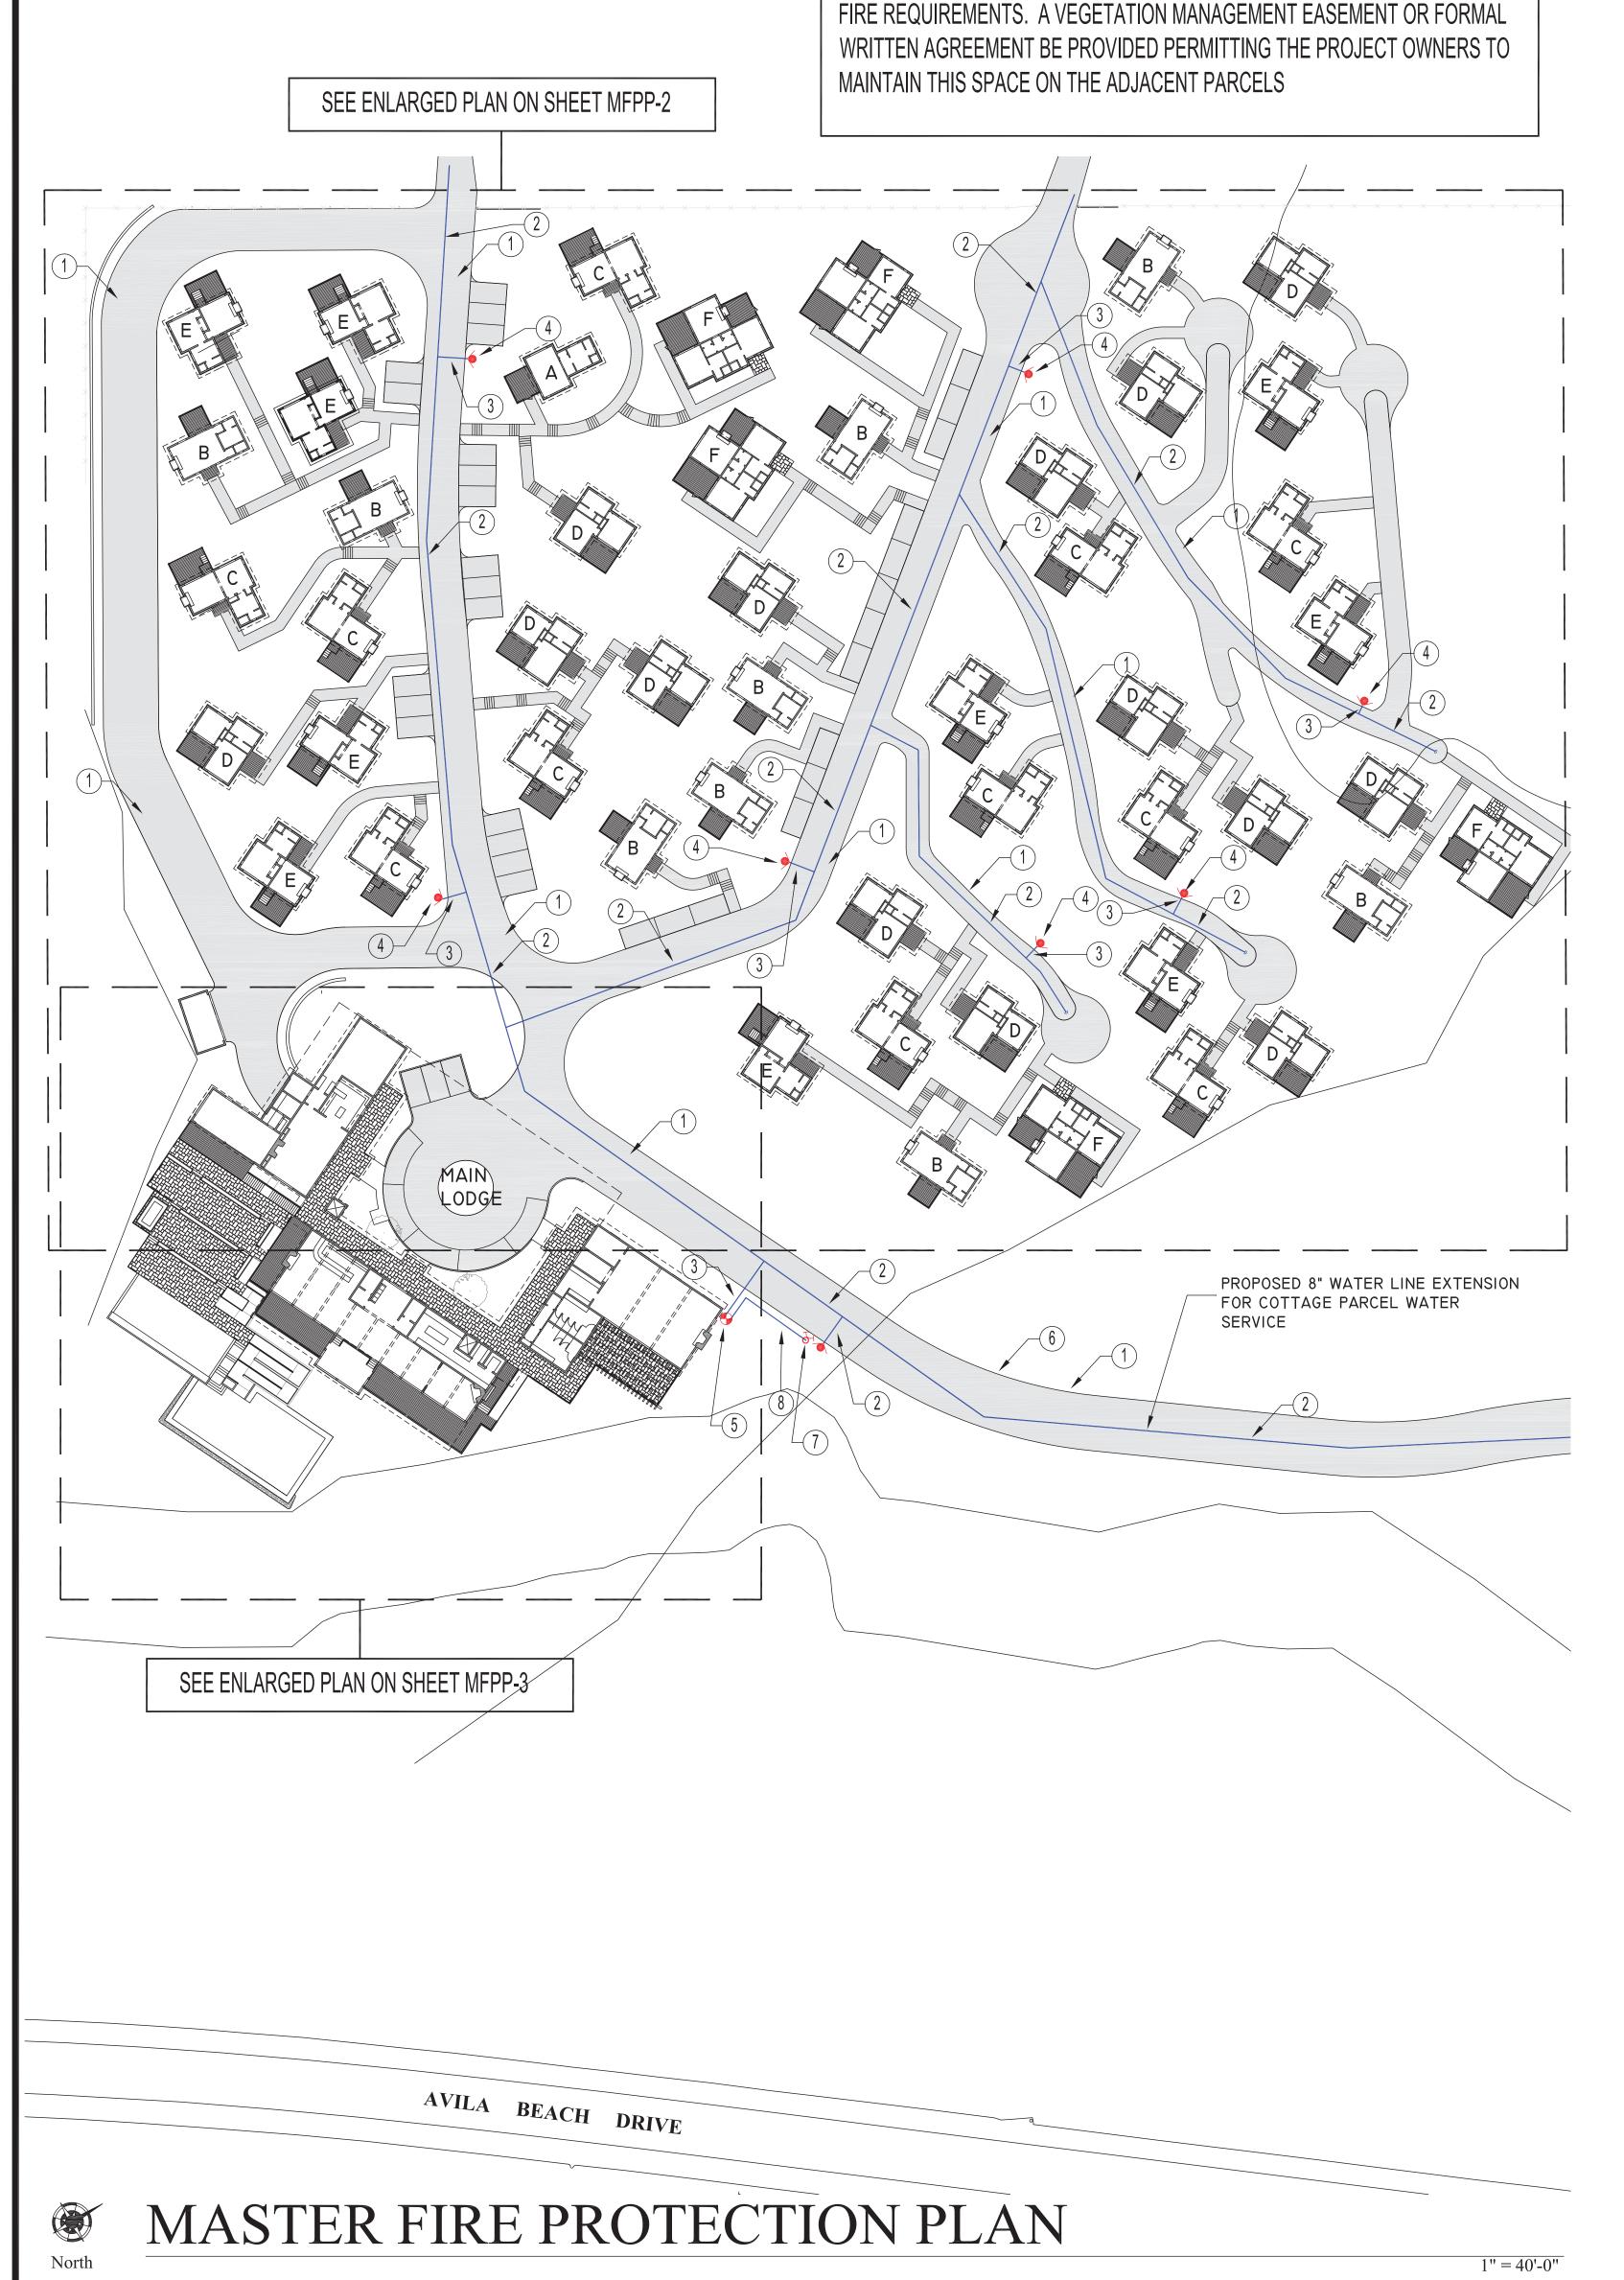

PROVIDE A MINIMUM 100 FT DEFENSIBLE SPACE AROUND BUILDINGS PER CAL

#### FIRE SPRINKLER DESIGN CRITERIA

MAIN BUILDING LODGE - 2016 EDITION OF NFPA 13
MONITORED SYSTEM

WEST PARKING STRUCTURE

2016 EDITION OF NFPA 13

MONITORED SYSTEM

2016 EDITION OF NFPA 13

MONITORED SYSTEM

COTTAGES, A THROUGH F 2016 EDITION OF NFPA 13D

#### DEFERRED SUBMITTAL & FIELD NOTES:

1. PROPOSED FIRE SPRINKLER SYSTEM INSTALLATION DETAILS, UNDERGROUND FIRE SERVICE PIPING INSTALLATION DETAILS, HYDRANT INSTALLATION DETAILS, THRUST BLOCK DETAILS AND GENERAL INSTALLATION DETAILS ARE TO BE SUBMITTED WITH SHOP DRAWINGS FOR APPROVAL AND PERMIT BY INSTALLING CONTRACTOR(S).

2. CONTRACTOR(S) TO PERFORM A SITE SURVEY AND FIELD WALK PRIOR TO SUBMITTING BID PROPOSAL FOR THE PROPOSED WORK, TO CONFIRM SITE CONDITIONS WITH RESPECT TO THE INSTALLATION OF THE SITE FIRE PROTECTION SYSTEMS. CONTRACTOR(S) WILL BE RESPONSIBLE FOR COORDINATION OF ALL PIPING INSTALLATION BASED UPON THE FIELD WALK AND THESE PLANS, REGARDLESS OF REQUIRED CHANGES IN PIPE ROUTING, WITHOUT ADDITIONAL COST TO OWNER.

### PRIOR TO BUILDING CONSTRUCTION THE FOLLOWING CONDITIONS MUST BE MET:

1. CREATE A DEFENSIBLE SPACE OF 100 FEET (OR PER CAL FIRE/SLO COUNTY FIRE DEPT. DIRECTION) AROUND THE PROPOSED STRUCTURES ON THIS PROPERTY. REMOVAL DOES NOT APPLY TO SINGLE SPECIMEN TREES, ORNAMENTAL SHRUBBERY OR SIMILAR PLANTS THAT ARE USED AS GROUND COVER IS THEY DO NOT FORM A MEANS OF RAPIDLY TRANSMITTING FIRE FROM THE NATIVE GROWTH TO ANY STRUCTURE.

2. FIRE DEPT. EMERGENCY ACCESS SHALL BE INSTALLED AND MADE SERVICABLE. ROADWAY PLANS, ACCEPTABLE TO THE FIRE DEPARTMENT, SHALL BE SUBMITTED FOR APPROVAL

3. SIGNS INDICATING "FIRE LANE - NO STOPPING" SHALL BE PLACED EVERY 150 FEET AS REQUIRED BY THE FIRE DEPARTMENT.

# KEY NOTES: FIRE DEPT. ACCESS - FIRE DEPARTMENT APPARATUS ACCESS ROAD DESIGN AND CONSTRUCTION TO COMPLY WITH THE PROVISIONS OF SAN LUIS OBISPO COUNTY FIRE DEPARTMENT STANDARDS. A 24'-0" MIN. WIDTH, MINIMUM 13'-6" CLEARANCE ALL WEATHER ACCESS ROAD SHALL

- WIDTH, MINIMUM 13'-6" CLEARANCE ALL WEATHER ACCESS ROAD SHALL BE PROVIDED AND MAINTAINED AT ALL TIMES FOR EMERGENCY ACCESS. ROAD TO BE CAPABLE OF SUPPORTING 75,000 LB. EMERGENCY VEHICLE.

  NEW 8" C900 DR18 PVC UG FIRE SERVICE TO NEW PRESSURIZED HYDRANTS AND NEW FIRE SPRINKLER SYSTEMS. INSTALLATION TO
- NEW 6" C900 DR18 PVC UG FIRE SERVICE TO NEW FIRE SPRINKLER SYSTEMS AND NEW SITE HYDRANTS. INSTALLATION TO COMPLY WITH THE PROVISIONS OF NFPA 24.
- INSTALL NEW PRESSURIZED FIRE HYDRANT AS SHOWN, LOCATED PER THE DIRECTION OF SAN LUIS OBISPO COUNTY FIRE DEPARTMENT DEVELOPMENT STANDARDS.

MINIMUM FIRE FLOW TO BE 1500 GPM AT 20 PSI.

COMPLY WITH THE PROVISIONS OF NFPA 24.

REMOVE OBSCURING VEGETATION, AND INSURE THAT THE FIRE DEPARTMENT CAN CONNECT TO THE 4" AND 2-1/2" HOSE CONNECTIONS AS PER COUNTY STANDARDS.

INSTALL SIGN LABELING HYDRANT LOCATION AND/OR INSTALL 3" BLUE REFLECTOR IN ACCESS ROAD ADJACENT TO HYDRANT.

- NEW AUTOMATIC FIRE SPRINKLER SYSTEM RISER LOCATION. THE SYSTEM IS TO BE DESIGNED AND INSTALLED IN COMPLETE ACCORDANCE WITH THE PROVISIONS OF THE 2016 EDITION OF NFPA 13, AND SAN LUIS OBISPO COUNTY FIRE DEPARTMENT REQUIREMENTS.
- PROVIDE ACCESS, FIRE DEPARTMENT KNOX BOX (IF APPLICABLE), AND ADDRESS PER SLOCFD STANDARDS.
- NEW 4" X 2-1/2" X 2-1/2" SIAMESE FIRE DEPARTMENT CONNECTION, (FDC) AND CHECK VALVE.
- NEW 4" C900 DR18 PVC UG FIRE SERVICE TO NEW FIRE DEPARTMENT CONNECTION. INSTALLATION TO COMPLY WITH THE PROVISIONS OF

#### 1

MASTER FIRE PROTECTION PLAN FOR THE PROPOSED AVILA BEACH COTTAGES PROJECT LOCATED IN SAN LUIS OBISPO COUNTYTHE PROJECT IS TO COMPLY WITH THE 2016 CALIFORNIA FIRE CODE, THE 2016 CALIFORNIA BUILDING CODE, AND ALL APPLICABLE COUNTY CODES AND STANDARDS.

#### BUILDING SUMMARY / BUILDING CODE DATA

SCOPE OF WORK

Main Building Lodge	NET SQ. FT.	GROSS SQ. FT.	Cottage "D"	NET 8Q. FT.	GROSS SQ
Main Level	8,909	9,491	Building	485	556
Lower Level-Below Ground (31%)	6,018	6,308	Porches & Decks	-	215
Lower Level-Above Ground (69%)	13,396	14,039	TOTAL	-	771
TOTAL	28,323	29,838	Total for All Cottage "D" Types		
Site Percentage (Above Ground Only)	0.92%	0.98%	Quantity of Cottage Type	15	
			Percentage of Cottage Type		0%
West Parking Structure	SQ	, FT.	Building	7,275 8,340	
Below Ground (50%)	5,	105	Porches & Decks		
Above Ground (50%)		105	TOTAL (Building, Porches, &Decks)	-	11,56
TOTAL	10	,209			
			Cottage "E"	NET SQ. FT.	GROSS SQ
			Building	523	597
			Porches & Decks	-	244
			TOTAL	_	841
Solid Waste Storage	NET SQ, FT,	GROSS SQ. FT.	Quantity of Cottage Type		9
Building	288	337	Percentage of Cottage Type	18%	
			Building	4,707	5,373
Cottage "A"	NET SQ. FT.	GROSS SQ. FT.	Porches & Decks	-	2,190
Building	415	480	TOTAL (Building, Porches, &Decks)		7,569
Porches & Decks	-	143			
TOTAL	-	623	Cottage "F"	NET ŠQ. FT.	GROSS &Q
Total for All Cottage "B" Types			Building	845	949
Quantity of Cottage Type		1	Porches & Decks	-	394
Percentage of Cottage Type	2	2%	TOTAL	-	
Building	415	480	Total for All Cottage "F" Types		
Porches & Decks	-	143	Quantity of Cottage Type 5		~
TOTAL (Building, Porches, &Decks)	-	623	Percentage of Cottage Type	10%	
			Building	4,225	4,745
Cottage "B"	NET SQ. FT.	GROSS SQ. FT.	Porches & Decks	-	1,970
Building	456	517	TOTAL (Building, Porches, &Decks)	-	6,715
Porches & Decks	-	140			
TOTAL	-	657	TOTAL Cottages on Site NET SQ. FT.		GROSS SQ
Total for All Cottage "B" Types			Total Quantity of Cottages	90	
Quantity of Cottage Type		9	Building	26,402	30,11
Percentage of Cottage Type		8%	Porches & Decks	-	11,11
Building	4,104	4,653	TOTAL	26,402	41,22
Porches & Decks	-	1,260	Site Percentage (Buildings Only)	2.72%	3.119
TOTAL (Building, Porches, &Decks)	-	5,913	Site Percentage (Buildings, Porches, &	Decks)	4,259
Cattana 11611	Appendix and	mana an an	TOPOPPLY AND TO DESCRIPTION OF THE PERSON OF	\$19-000 Hall \$400	pp.ozo z c
Cottage "C"	NET SQ, FT,	GROSS SQ. FT.	TOTAL All Building on Site	NET SQ, FT,	GROSS SQ
Building	516	593	TOTAL Above Grade	35,691	40,07
Porches & Decks	-	211	Site Percentage (Above Grade Only)	3.68%	4.149
TOTAL	-	804	TOTAL Above & Below Grade	55,105	60,42
Total for All Cottage "C" Types					
Quantity of Cottage Type		11			
Percentage of Cottage Type		2%			
Building	5,676	6,523			
	-	2,321			
Porches & Decks TOTAL (Building, Porches, &Decks)	-	8,844			

THIS MASTER FIRE PROTECTION PLAN INCLUDES THE FOLLOWING FIRE PROTECTION SYSTEMS IN SUPPORT OF THE CONSTRUCTION OF THE NEW COMMERCIAL BLDGS.

1. FIRE DEPARTMENT APPARATUS ACCESS ROAD DESIGN AND CONSTRUCTION TO COMPLY WITH THE PROVISIONS OF SAN LUIS OBISPO COUNTY FIRE DEPARTMENT STANDARDS. A 24'-0" MIN. WIDTH, MINIMUM 13'-6" CLEARANCE ALL WEATHER ACCESS ROAD SHALL BE PROVIDED AND MAINTAINED AT ALL TIMES FOR EMERGENCY ACCESS. ROAD TO BE CAPABLE OF SUPPORTING 75,000 LB. EMERGENCY VEHICLE.

- 2. NEW 6" & 8" C900 DR18 UNDERGROUND FIRE SERVICE LINES TO SUPPLY SITE HYDRANTS AND BUILDING FIRE SPRINKLER SYSTEMS. SYSTEM TO BE INSTALLED AND INSPECTED PER NFPA 24 REQUIREMENTS.
- 3. INSTALL NEW PRESSURIZED FIRE HYDRANTS AS SHOWN, LOCATED PER THE DIRECTION OF SAN LUIS OBISPO COUNTY FIRE DEPARTMENT DEVELOPMENT STANDARDS.

#### MINIMUM FIRE FLOW TO BE 1500 GPM AT 20 PSI.

REMOVE OBSCURING VEGETATION, AND INSURE THAT FIRE DEPARTMENT CAN CONNECT TO THE 4" AND 2-1/2" HOSE CONNECTIONS AS PER COUNTY STANDARDS. INSTALL SIGN LABELING HYDRANT LOCATION AND/OR INSTALL 3" BLUE REFLECTOR IN ACCESS ROAD ADJACENT TO HYDRANT.

- 4. UNDERGROUND FIRE SERVICE PIPING TO HAVE THRUST BLOCKS, VALVES AND ALL APPURTENANCES TO BE INSTALLED PER THE REQUIREMENTS OF NFPA 24.
- 5. INSTALL NEW AUTOMATIC WET FIRE SPRINKLER SYSTEMS IN THE PROPOSED COMMERCIAL BUILDINGS. THE SYSTEMS ARE TO BE DESIGNED AND INSTALLED IN COMPLETE ACCORDANCE WITH THE PROVISIONS OF THE 2016 EDITION OF NFPA 13 AND THE SAN LUIS OBISPO COUNTY FIRE DEPARTMENT.

8. INSTALL FIRE SPRINKLER FIRE ALARM MONITORING SYSTEMS FOR THE PROPOSED BUILDINGS PER COUNTY REQUIREMENTS. SYSTEMS TO BE CONTINUOUSLY MONITORED BY A UL LISTED CENTRAL STATION, WITH AUTOMATIC FIRE DEPARTMENT NOTIFICATION UPON SYSTEM ACTIVATION.

- 9. INSTALL FIRE EXTINGUISHERS THROUGHOUT BUILDINGS IN ACCORDANCE WITH THE CALIFORNIA FIRE CODE, AND SLOCFD REQUIREMENTS.
- 10. GATE ACCESS, SITE ADDRESSING AND FIRE LANE SIGNAGE MUST BE PROVIDED IN ACCORDANCE WITH THE CALIFORNIA FIRE CODE AND SLOCFD REQUIREMENTS.

11. FIRE ALARM SYSTEM TO BE INSTALLED PER THE REQUIREMENTS OF THE 2016 EDITION OF THE CALIFORNIA FIRE CODE AND INSTALLED IN ACCORDANCE WITH THE PROVISIONS OF THE 2016 EDITION OF NFPA 72.

## PROPOSED WATER SUPPLY

Ex. Water Tanks

Proposed 8-in Waterline

Proposed 8-in Waterline

Extension for Cottage

Parcel Water Service

Looping (SMMWC Request

Extension for System

100 & 200

Proposed Water

Tie-In at Tank 200

**Proposed Water** 

Tie-In Location

Proposed Replacement

of Ex. 8-in AC Pipe

(SMMWC Request

NO SCALE

Figure 2

**Water Service** 

Ex. Water System


8" Loop Extension

Ex. 8" AC Replacement

8" Cottage Service

	REVISION	DESCRIPTION DATE	BY
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Collings & Associates, LLC
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www.collingsandassociates.com

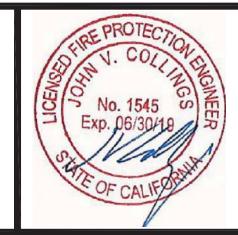

AVILA COTTAGES

AVILA BEACH DRIVE
SAN LUIS OBISPO, CA 93401

MASTER FIRE PROTECTION PLAN OVERALL SITE PLAN P.T.

CHECKED:

J.C.

SCALE:

AS SHOWN

DATE:

03/22/18

SHEET MFPP-1



KEY NOTES:

- 1 FIRE DEPT. ACCESS FIRE DEPARTMENT APPARATUS ACCESS ROAD DESIGN AND CONSTRUCTION TO COMPLY WITH THE PROVISIONS OF SAN LUIS OBISPO COUNTY FIRE DEPARTMENT STANDARDS. A 24'-0" MIN. WIDTH, MINIMUM 13'-6" CLEARANCE ALL WEATHER ACCESS ROAD SHALL BE PROVIDED AND MAINTAINED AT ALL TIMES FOR EMERGENCY ACCESS. ROAD TO BE CAPABLE OF SUPPORTING 75,000 LB. EMERGENCY VEHICLE.
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NOTE: THE FOLLOWING REFERENCES ARE MANDATORY SUPPORTING DOCUMENTS TO THIS MFPP:

1. COLLINGS AND ASSOCIATES MFPP SUMMARY REPORT DATED 11/17/17.


DESCRIPTION DATE BY REVISION

Collings & Associates, LLC
Fire Protection Engineering
260 Maple Court, Suite 241, Ventura, Ca 93003
Phone: (805) 658-0003 Fax: (805) 658-0044
www.collingsandassociates.com



AVILA COTTAGES AVILA BEACH DRIVE

SAN LUIS OBISPO, CA 93401 MASTER FIRE PROTECTION PLAN SITE PLAN: COTTAGES CHECKED: SCALE: AS SHOWN 03/22/18 MFPP-2

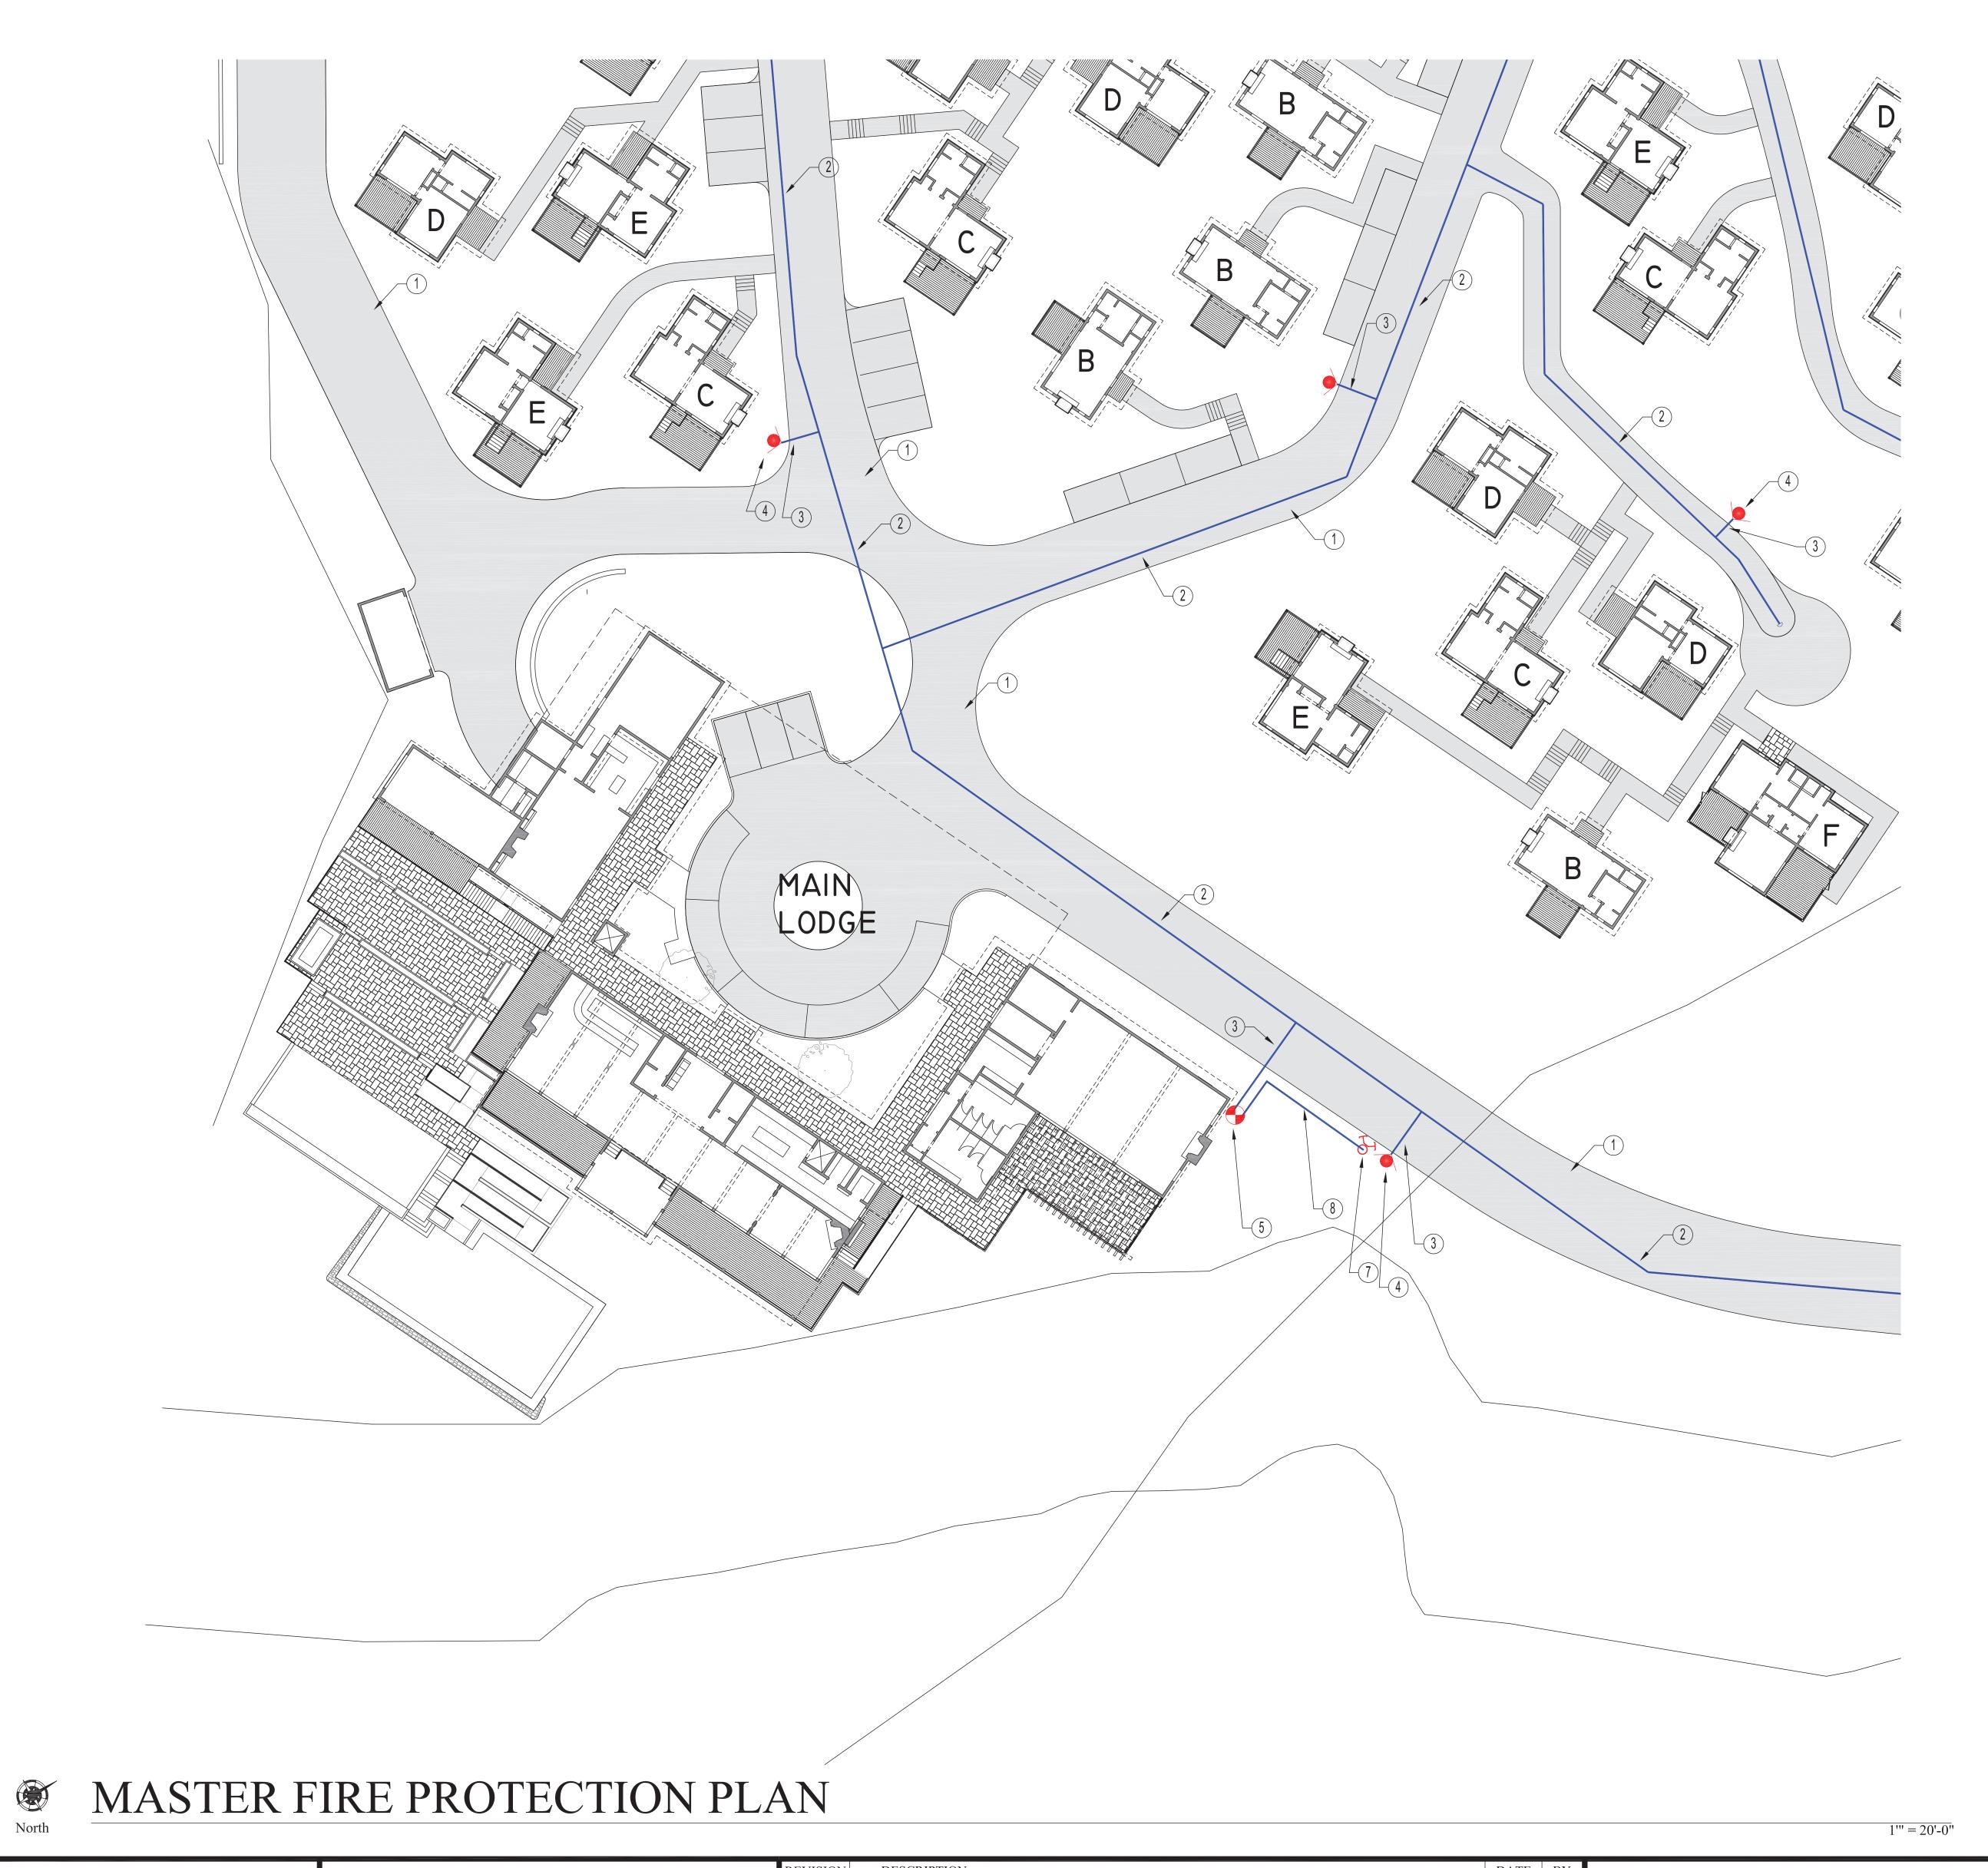

KEY NOTES:

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PD O IE

No. 1545 SO Exp. 06/30/19

AVILA COTTAGES

AVILA BEACH DRIVE
SAN LUIS OBISPO, CA 93401

CHECKED:
J.C.

SCALE:
AS SHOWN

DATE:
03/22/18

SHEET MFPP-3

SHEET TITLE: MASTER FIRE PROTECTION PLAN SITE PLAN: MAIN LODGE

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REVISION DESCRIPTION

A DATE BY

C DATE BY

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Fire Protection Engineering
260 Maple Court, Suite 241, Ventura, Ca 93003
Phone: (805) 658-0003 Fax: (805) 658-0044
www.collingsandassociates.com

ARCTOSTAPHYLOS EDMUNDSII 'CARMEL SUR'

ARCTOSTAPHYLOS 'JOHN DOURLEY' MANZANITA

VERBENA LILACINA 'DE LA MINA' CEDROS ISLAND VERBENA

Job Number: Project Number

Date: 09/24/2018

DESCRIPTION

03/27/18 PLANNING SUBMITTAL 09/24/18 PLANNING RESUBMITTAL

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CORREA 'IVORY BELLS'

WHITE AUSTRALIAN FUCHSIA

CISTUS SALVIFOLIUS SAGE LEAF ROCK ROSE

RHAMNUS CALIFORNICA

COFFEEBERRY

RHAPIOLEPIS INDICA 'CLARA'

WHITE INDIAN HAWTHORN

CEANOTHUS GRISEUS HORIZONTALIS 'YANKEE POINT'

WOODWARDIA FIMBRIATA GIANT CHAIN FERN

ACACIA REDOLENS 'LOW BOY' PROSTRATE ACACIA



bb Number: Project Number

09/24/2018

DESCRIPTION

03/27/18 PLANNING SUBMITTAL 09/24/18 PLANNING RESUBMITTAL

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LOCAL WILDFLOWER MIX

REVEGETATION PLANTING AREA NOTES



MIMULUS AURANTIACUS -BUSH MONKEY FLOWER

ORCHARD



ROMNEYA COULTERI -MATILIJA POPPY




SALVIA APIANA -WHITE SAGE



SALVIA SPATHACEA -**HUMMINGBIRD SAGE** 




NATIVE CEANOTHUS

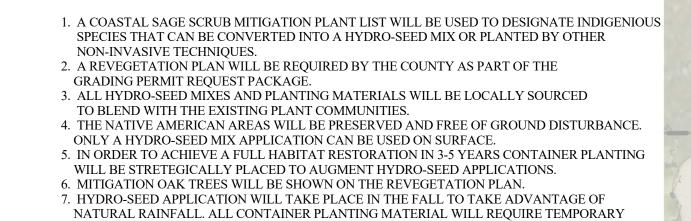



ABOVE GROUND IRRIGATION AS THE NATIVE SHRUB SPECIES WILL BE ABLE TO PERSIST WITHOUT WATERING ONCE ESTABLISHED.

8. ALL EXISTING NATIVE PLANT MATERIAL WILL BE IDENTIFIED AND PRESERVED.


9. PLAN WILL INCLUDE FIRE SAFETY SETBACKS AND VEGETATIVE FUEL REDUCTION AREAS. 10. ALL DESIGNATED PLANTING IS REQUIRED TO HAVE A LOW WATER USEAGE.

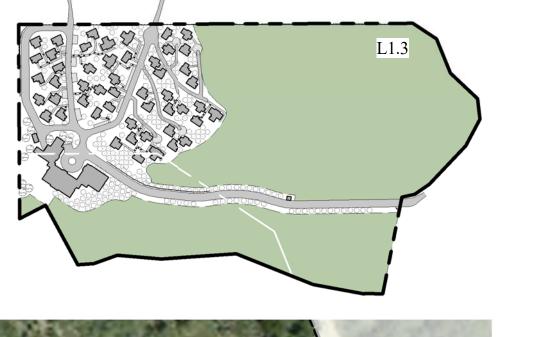

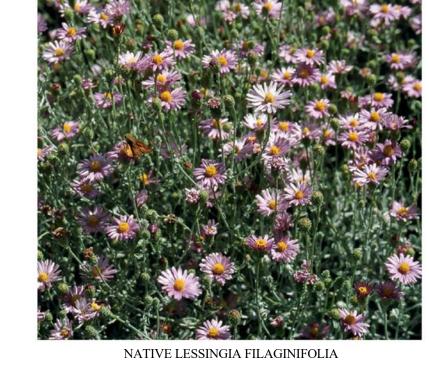

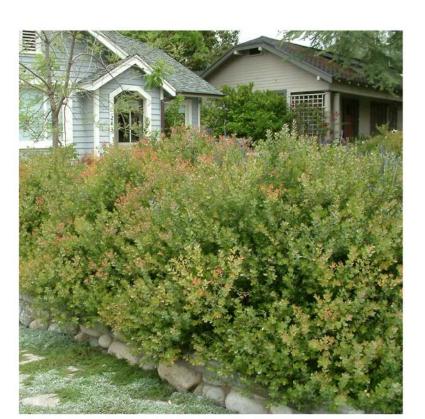

NATIVE ARCTOSTAPHYLOS - MANZANITA

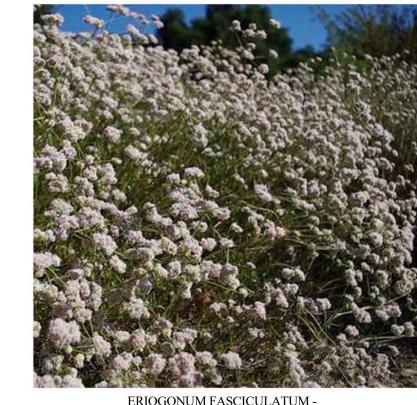


ERIOGONUM FASCICULATUM -CALIFORNIA BUCKWHEAT









PACIFIC OCEAN

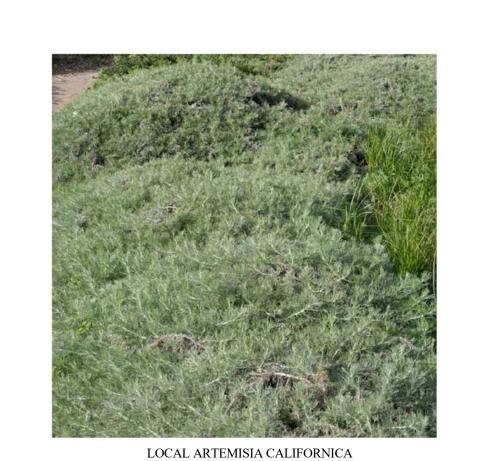

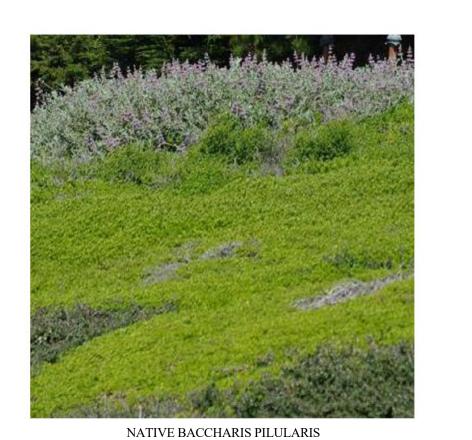

ENCELIA CALIFORNICA -CALIFORNIA BUSH SUNFLOWER

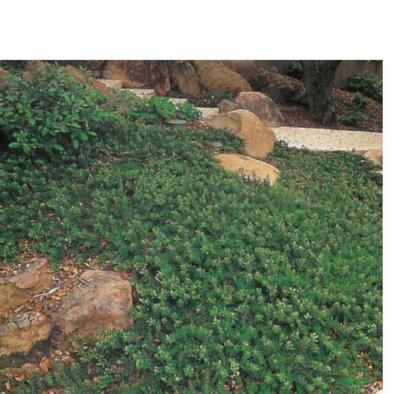

NATIVE ARCTOSTAPHYLOS - MANZANITA

	Job Number:
	Sheet
TRUE NORTH	

DESCRIPTION

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