

COUNTY OF SAN LUIS OBISPO DEPARTMENT OF PLANNING & BUILDING TREVOR KEITH, DIRECTOR

THIS IS A NEW PROJECT REFERRAL

DATE:	9/11/2018
ГО:	1 st District Legislative Assistant, Building Division, Public Works, Environmental Health, Sheriff, Templeton CSD, Templeton Advisory Group
FROM:	Steven Orozco (<u>sorozco@co.slo.ca.us</u> or 805-788-2084)
PROJECT DESC facility to be lo APN(s): 040-15	
	er with your comments attached no later than 14 days from receipt of this referral. Spond within 60 days. Thank you.
PART I: IS THE	ATTACHED INFORMATION ADEQUATE TO COMPLETE YOUR REVIEW? YES (Please go on to PART II.) NO (Call me ASAP to discuss what else you need. We have only 10 days in which we must obtain comments from outside agencies.)
OF REVI □	HERE SIGNIFICANT CONCERNS, PROBLEMS OR IMPACTS IN YOUR AREA EW? YES (Please describe impacts, along with recommended mitigation measures to reduce the impacts to less-than-significant levels, and attach to this letter.) NO (Please go on to PART III.)
Please a	CATE YOUR RECOMMENDATION FOR FINAL ACTION. Settach any conditions of approval you recommend to be incorporated into the sample approval, or state reasons for recommending denial.
F YOU HAVE "N	IO COMMENT," PLEASE SO INDICATE, OR CALL.
Date	Name Phone
Jaic	Name Filone



APPLICATION TYPE - CHECK ALL THAT APPLY ☐ Emergency Permit ☐ Tree Permit ☑ Minor Use Permit DRC2018-00151 Conditional Use Permit/Development Plan Plot Plan Curb, Gutter & Sidewalk Waiver Other Site Plan Minor Use Permit ☐ Surface Mining/Reclamation Plan ☐ Zoning Clearance 040-153-018 / 3990 RUTH WAY Amendment to approved land use permit Variance TWIN ARBOR ANALYTICAL **CANNABIS** APPLICANT INFORMATION Check box for contact person assigned to this project Patrajac Family 1505+ Daytime Phone 805-674-8698 Landowner Name Mailing Address 2000 LOOKOG+ DC. Temple ton Zip Code 934/5 Email Address: Nich DN Pohrajac. Com ☐ Applicant Name Carter Daytime Phone (404 Mailing Address 3990 Roble SZip Code Email Address: Foctes+ R7400 Come: 1 Agent Name Daytime Phone Mailing Address Zip Code Email Address: PROPERTY INFORMATION Total Size of Site: 2,350 Assessor Parcel Number(s): 040 - 153 - 014 Legal Description: Angustical Address of the project (if known): 3990 Ruth way Directions to the site (including gate codes) - describe first with name of road providing primary access to the site, then nearest roads, landmarks, etc.: See attachment Describe current uses, existing structures, and other improvements and vegetation on the property: Custentia see attachment PROPOSED PROJECT Describe the proposed project (inc. sq. ft. of all buildings): See LEGAL DECLARATION I, the owner of record of this property, have completed this form accurately and declare that all statements here are true. I do hereby grant official representatives of the county authorization to inspect the subject property. Property owner signature FOR STAFF USE ONLY

LAND USE PERMIT APPLICATION PACKAGE SAN LUIS OBISPO COUNTY PLANNING & BUILDING http://www.slocounty.ca.gov/planning.htm

PAGE 4 OF 16 JULY 1, 2017 PLANNING@CO.SLO.CA.US



LAND USE PERMIT APPLICATION

San Luis Obispo C	ounty Department o	of Planning and	Building		File No		
Type of project:	Commercial	☐ Industrial	Reside	ntial 🗌 R	Recreational	☑ Other	ana bil
Describe any modi applicable): //	fications/adjustmen <u>Λ</u>	ts from ordinan	ce needed a	nd the reaso	-		
Describe existing a	nd future access to	the proposed p	oroject site: _	Poblic	roads		
Surrounding parc If yes, what is the a	el ownership: D creage of all prope	o you own adja rty you own tha	acent propert t surrounds t	ty? ☐ Y the project s	es 🔲 No ite?		
Surrounding land please specify all a North:	gricultural uses):						
East: _ Comw							
For all projects, and Square footage and Buildings: s Paving: s Total area of all paving and area of grading Number of parking Number of trees to Setbacks: From Community Systems of the set of	d percentage of the q. feet% q. feet% wing and structures: ag or removal of grospaces proposed:be removed:but	und cover: A/A Right well Sha	Oximately) the Landscapin Other (special Height of the Landscapin Landscapin Control Landscapin Lan	at will be using: cify) s allest structure eft Other for provision:	sq. feet q. feet ure:	owing: _% acres acres Back	
Proposed sewage ☑ Community System Do you have a valid	disposal: Indiviem - List the agence	vidual on-site sy cy or company r	ystem esponsible f	☐ Other or sewage d	lisposal: <u>ÎC</u> n	Apleton Csi	Þ
Fire Agency: Lis	t the agency respor	nsible for fire pr	otection: <u>Te</u>	mpleton	Fire		
For commercial/in Total outdoor use a Total floor area of a	rea: 🔼 🗹 sq. f	eet 🗌 acres		feet			
For residential pro Number of residenti Total floor area of a Total of area of the	al units: Il structures includir	Num ng upper stories	nber of bedro s, but not gar parking spac	ages and ca	arports:	_ sf	



San Luis Obispo County Department of Planning and Building

File No	

The California Environmental Quality Act (CEQA) requires all state and local agencies to consider and mitigate environmental impacts for their own actions and when permitting private projects. The Act also requires that an environmental impact report (EIR) be prepared for all actions that may significantly affect the quality of the environment. The information you provide on this form will help the Department of Planning and Building determine whether or not your project will significantly affect the quality of the environment.

To ensure that your environmental review is completed as quickly as possible, please remember to:

- a. Answer **ALL** of the questions as accurately and completely as possible.
- b. Include any additional information or explanations where you believe it would be helpful or where required. Include additional pages if needed.
- c. If you are requesting a land division or a re-zoning, be sure to include complete information about future development that may result from the proposed land division or rezoning.
- d. Include references to any reports or studies you are aware of that might be relevant to the questions asked or the answers you provide.

Should a determination be made that the information is inaccurate or insufficient, you will be required to submit additional information upon request.

Physical Site Characteristic Information

Your site plan will also need to show the information requested here:

1.	Describe the topography of the site:		
	Level to gently rolling, 0-10% slopes: Ail acres		
	Moderate slopes - 10-20%: acres		
	20-30%: acres		
	Steep slopes over 30%: acres		
2.	Are there any springs, streams, lakes or marshes on or near the s If yes, please describe: <i>NA</i>	site? ☐ Yes ☒ No	
3.	Are there any flooding problems on the site or in the surrounding of the second of the surrounding of the second o	area? ☐ Yes ☒ No	
4.	Has a drainage plan been prepared? If yes, please include with application.	☐ Yes ☑ No	
5.	Has there been any grading or earthwork on the project site? If yes, please explain: 1/A	☐ Yes ☒ No	
6.	Has a grading plan been prepared? If yes, please include with application.	☐ Yes ☒ No	
7.	Are there any sewer ponds/waste disposal sites on/adjacent to the	e project?	
8.	Is a railroad or highway within 300 feet of your project site?	☐ Yes ☒ No	
9.	Can the proposed project be seen from surrounding public roads? If yes, please list:	Yes 🗓 No	

Water Supply Information

1.	What type of water supply is proposed? ☐ Individual well ☐ Shared well ☐ Community water system
2.	What is the proposed use of the water? Residential Agricultural - Explain
~	☐ Commercial/Office - Explain <u>Commercial</u> Industrial – Explain
3.	What is the expected daily water demand associated with the project? NA
4.	How many service connections will be required? NA
5.	Do operable water facilities exist on the site? ☐ Yes ☑ No ☐ If yes, please describe:
6.	Has there been a sustained yield test on proposed or existing wells? Yes No If yes, please attach.
7.	Does water meet the Health Agency's quality requirements?
	Bacteriological?
	Chemical?
	Physical ☐ Yes ☐ No
0.000	Water analysis report submitted? ☐ Yes ☑ No
8.	Please check if any of the following have been completed on the subject property and/or submitted
	to County Environmental Health.
	☐ Will Serve Letter ☐ Pump TestHours / GPM
	☐ Surrounding Well Logs ☐ Hydrologic Study ☐ Other
Plea	se attach any letters or documents to verify that water is available for the proposed project.
Sew	rage Disposal Information
lf an	on-site (individual) subsurface sewage disposal system will be used:
1.	Has an engineered percolation test been accomplished?
	☐ Yes ☑ No If yes, please attach a copy.
	What is the distance from proposed leach field to any neighboring water wells? Miles feet
3.	Will subsurface drainage result in the possibility of effluent reappearing in surface water or on
	adjacent lands, due to steep slopes, impervious soil layers or other existing conditions?
	☐ Yes 区 No
4.	Has a piezometer test been completed?
	Yes No If 'Yes', please attach.
5	
٥.	Will a Waste Discharge Permit from the Regional Water Quality Control Board be required?
	Yes No (a waste discharge permit is typically needed when you exceed 2,500 gallons per
	day)
If a d	community sewage disposal system is to be used:
1.	Is this project to be connected to an existing sewer line? Yes No
100	Distance to nearest sewer line: See attachments Location of connection: See attachments
2	What is the amount of proposed flow? 50 GPD
۷.	Doop the existing collection treatment and disposal parties because a deliberation of the second and the second
3.	Does the existing collection treatment and disposal system have adequate additional capacity to
	accept the proposed flow? ✓ Yes No

<u>Soli</u>	d Waste Information
2. 3.	What type of solid waste will be generated by the project? Domestic Industrial Agricultural Other, please explain? Name of Solid Waste Disposal Company: Name of Solid Waste Disposal Storage in relation to buildings? Does your project design include an area for collecting recyclable materials and/or composting materials? Yes No
Con	nmunity Service Information
2. 3.	Name of School District: Templeton Unified School district Location of nearest police station: 356 N Main St. Templeton, CA 93465 Location of nearest fire station: 206 5th St. Templeton, CA 93465 Location of nearest public transit stop: Theatle Drive Gt Rancho Pasc Rd. Are services (grocery/other shopping) within walking distance (1/2 mile or closer) of the project?
<u>Hist</u>	oric and Archeological Information MA
3.	Please describe the historic use of the property:
Only chai	/ complete this section if you are proposing a commercial or industrial project or zoning nge. A√A , No Changes
2.	Days of Operation: Hours of Operation: Hours of Operation: Hours of Operation:
4.	Will this project produce any emissions (i.e., gasses, smoke, dust, odors, fumes, vapors)? Yes No If yes, please explain:
5.	Will this project increase the noise level in the immediate vicinity? Yes No If yes, please explain:
6. 7.	(If loud equipment is proposed, please submit manufacturers estimate on noise output.) What type of industrial waste materials will result from the project? Explain in detail: Please See Attached Document "Map Chart 137" Pg 14 Will hazardous products be used or stored on-site? Yes No
8.	If yes, please describe in detail: Please See attached document "MOP Checritist" Pa 14 Has a traffic study been prepared? Yes No If yes, please attach a copy. Please estimate the number of employees, customers and other project-related traffic trips to or
J.	from the project: Between 7:00 - 9:00 a.m Between 4:00 to 6:00 p.m

	Are you proposing any special measures (carpooling, public transit, telecommuting) to reduce automobile trips by employees
<u>Agri</u>	cultural Information
	γ complete this section if your site is: 1) Within the Agricultural land use category, or 2) ently in agricultural production. $\mathcal{N}\beta$
2.	Is the site currently in Agricultural Preserve (Williamson Act)? If yes, is the site currently under land conservation contract? If yes In No If your land is currently vacant or in agricultural production, are there any restrictions on the crop productivity of the land? That is, are there any reasons (i.e., poor soil, steep slopes) the land cannot support a profitable agricultural crop? Please explain in detail:
<u>Spe</u>	cial Project Information
1.	Describe any amenities included in the project, such as park areas, open spaces, common recreation facilities, etc.(these also need to be shown on your site plan):
2.	Will the development occur in phases? ☐ Yes ☒ No If yes describe: ☒ Ā
3.	Do you have any plans for future additions, expansion or further activity related to or connected with this proposal? Yes No If yes, explain:
4.	Are there any proposed or existing deed restrictions? Yes No If yes, please describe: N
Ener	gy Conservation Information
- 1.	Describe any special energy conservation measures or building materials that will be incorporated into your project *: _X/A
	*The county's Building Energy Efficient Structures (BEES) program can reduce your construction permit fees. Your building must exceed the California State Energy Standards (Title 24) in order to qualify for this program. If you are interested in more information, please contact the Building Services Division of the Department of Planning and Building at (805) 781-5600.
Envi	ronmental Information
1.	List any mitigation measures that you propose to lessen the impacts associated with your project:
2.	Are you aware of any unique, rare or endangered species (vegetation or wildlife) associated with the project site? Yes X No If yes, please list:

3.	Are you aware of any previous environmental determinations for all or portions of this property? ☐ Yes ☑ No If yes, please describe and provide "ED" number(s): ☑//				
Oth	Other Related Permits				
1.	List all permits, licenses or government approvals that will be required for your project (federal, state and local): BCC - TeSting laboratory license				
	(If you are unsure if additional permits are required from other agencies, please ask a member of the Planning Department staff currently assigned to the project				

TWIN ARBOR LABS MUP

Application Checklist

PROJECT DESCRIPTION

The applicant is seeking a Minor Use Permit for a commercial analytical laboratory located in Templeton, CA. The operation will occupy Suite D on the second floor of the building located at 3990 Ruth Way. The project site is located in the Commercial Services land use category. The APN for this parcel is 040-153-018. The laboratory is separated into active laboratory space and office space with approximately 1,500 being dedicated for active laboratory work space.

Minor Use Permit Application - Required Contents (per Chapter 22.60)

Agricultural Buffers

No proposed agricultural buffers required. Adjacent parcels are all zoned Commercial Services and/or Commercial Retail

Archeological Report

An Archeological report is not required for as this Minor Use Permit will be located in existing commercial space.

Botanical Report

A Botanical report is not required for as this Minor Use Permit will be located in enclosed commercial space.

Biological Report

A Biological report is not required for as this Minor Use Permit will be located in enclosed commercial space.

Building Site Envelopes

This Minor Use Permit only encompasses the commercial space in Unit D of the commercial building shown in the site plan. Future construction activities that would expand the building site envelope are not expected at this time.

Noise Study

Mechanical noise during operations is not expected to exceed County standards or adversely impact surrounding noise sensitive uses.

Tree inventory plan

The applicant currently leases space and has no plans for any tree removal on site plan. **Table 1** below details current tree locations, approximate height and species. A Tree Locations map is shown in **Figure 6**.

Tree #	Tree Location (Lat/Long)	Approximate Height (ft)	Species	
1	35 deg 34'10.93" N 120 deg 41'43.30" W	20-25	American Sycamore	
2	35 deg 34' 10.81" N 120 deg 41'43.01" W	20-25	American Sycamore	
3	35 deg 34' 10.30" N 120 deg 41'42.99" W	20-25	American Sycamore	

35 deg 34' 10.30" N 120 deg 41'42.88" W	20-25	American Sycamore
35 deg 34' 11.56" N 120 deg 41'42.57" W	20-25	American Sycamore
35 deg 34' 11.85" N 120 deg 41'42.71" W	20-25	American Sycamore
35 deg 34' 11.86" N 120 deg 41'42.66" W	20-25	American Sycamore
35 deg 34' 11.82" N 120 deg 41'42.50" W	20-25	American Sycamore
35 deg 34' 11.82" N 120 deg 41'42.33" W	20-25	American Sycamore
35 deg 34' 11.56" N 120 deg 41'42.57" W	20-25	American Sycamore
35 deg 34' 11.83" N 120 deg 41'42.01" W	20-25	American Sycamore
35 deg 34' 11.58" N 120 deg 41'41.98" W	20-25	American Sycamore
35 deg 34' 11.65" N 120 deg 41'41.50" W	20-25	American Sycamore
35 deg 34' 11.82" N 120 deg 41'41.45" W	20-25	American Sycamore
35 deg 34' 11.81" N 120 deg 41'41.22" W	20-25	American Sycamore
35 deg 34' 11.34" N 120 deg 41'41.21" W	10-15	Lagerstoemia
35 deg 34' 11.35" N 120 deg 41'41.47" W	10-15	Lagerstoemia
35 deg 34' 11.36" N 120 deg 41'41.71" W	10-15	Lagerstoemia
35 deg 34' 11.35" N 120 deg 41'41.99" W	10-15	Lagerstoemia
	35 deg 34' 11.56" N 120 deg 41'42.57" W 35 deg 34' 11.85" N 120 deg 41'42.71" W 35 deg 34' 11.86" N 120 deg 41'42.66" W 35 deg 34' 11.82" N 120 deg 41'42.50" W 35 deg 34' 11.82" N 120 deg 41'42.33" W 35 deg 34' 11.56" N 120 deg 41'42.57" W 35 deg 34' 11.58" N 120 deg 41'42.01" W 35 deg 34' 11.58" N 120 deg 41'41.98" W 35 deg 34' 11.65" N 120 deg 41'41.50" W 35 deg 34' 11.82" N 120 deg 41'41.45" W 35 deg 34' 11.81" N 120 deg 41'41.22" W 35 deg 34' 11.34" N 120 deg 41'41.21" W 35 deg 34' 11.35" N 120 deg 41'41.47" W 35 deg 34' 11.35" N 120 deg 41'41.47" W 35 deg 34' 11.35" N 120 deg 41'41.71" W	35 deg 34' 11.56" N 120 deg 41'42.57" W 20-25 35 deg 34' 11.85" N 120 deg 41'42.71" W 20-25 35 deg 34' 11.86" N 120 deg 41'42.66" W 20-25 35 deg 34' 11.82" N 120 deg 41'42.50" W 20-25 35 deg 34' 11.82" N 120 deg 41'42.33" W 20-25 35 deg 34' 11.56" N 120 deg 41'42.57" W 20-25 35 deg 34' 11.83" N 120 deg 41'42.01" W 20-25 35 deg 34' 11.58" N 120 deg 41'41.98" W 20-25 35 deg 34' 11.65" N 120 deg 41'41.50" W 20-25 35 deg 34' 11.82" N 120 deg 41'41.50" W 20-25 35 deg 34' 11.81" N 120 deg 41'41.45" W 20-25 35 deg 34' 11.81" N 120 deg 41'41.22" W 20-25 35 deg 34' 11.34" N 120 deg 41'41.21" W 10-15 35 deg 34' 11.35" N 120 deg 41'41.47" W 10-15

Table 1: Site Plan Tree Inventory

Visual Analysis

This property is over 1000 feet from significant visual corridors, as identified in the Open Space Element or the Land Use Element. The office is also located in a nondescript building away from main thoroughfares.

Traffic Analysis

Traffic generated by the analytical laboratory will be limited to employees only. The lab is not open to the public and hours of operation will conform to normal business hours (9am - 5pm). Sample Collection will be scheduled and conducted by a single employee. Laboratory personnel commute traffic is also included in the below analysis and is based on a headcount of 4 full-time employees.

Traffic impact of sampling schedule

Sampling of cannabis and cannabis related products is to be scheduled for Tuesday and Thursday of each week. Sampling is to be conducted by an employee of Twin Arbor Analytical. Routes will be determined prior to sampling to reduce sampling time and distances traveled. This schedule is designed to reduce travel times, reduce operational expenses and limit traffic to and from the laboratory.

Sampling is to be scheduled by the preceding Friday to give enough time to determine the best possible route for the following Tuesday. Any sampling scheduled on Monday will be conducted the following Thursday. A single sampler will travel to each location and sample product. All sampling will be conducting in a single run before sampler returns for laboratory intake. Emergency or rushed sampling can be scheduled at an additional cost.

Please see the following traffic study based on estimated traffic in 2018:

Traffic Analysis – Trip Generation								
Time of Year	Headcount	Daily	Peak Hour Trips					
Time or rear	neadcount	Trips	Weekday AM			Weekday PM		
Typical Operations			In	Out	Total	In	Out	Total
Sample Collection	1	2	0	1	1	1	0	1
Commuting	4	8	4	0	4	0	4	4
	TOTAL:	10	5	0	5	0	5	5

Table 2: Traffic Analysis

Parking Plan

Parking is non-assigned in accordance to the lease – this is true for all the tenants of the building. Parking Area is show in **Figure 1**, representing 23 spaces (22 standard and 1 accessible). In addition to the off-street parking, onstreet parking is available along Ruth Way. Our current parking conditions are adequate for the expected customer and employee requirements.

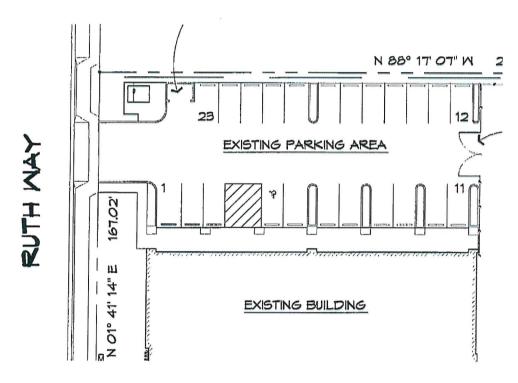


Figure 1: Existing Parking Area

Site Location and Dimensions (also in Site Plan)

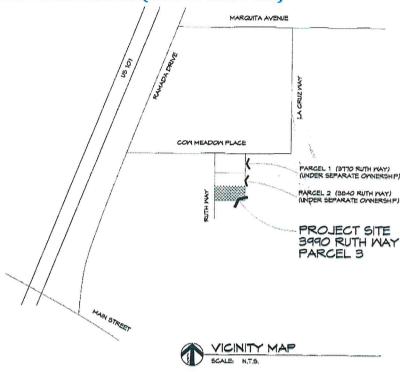


Figure 2: Site Location - APN# 040-153-018

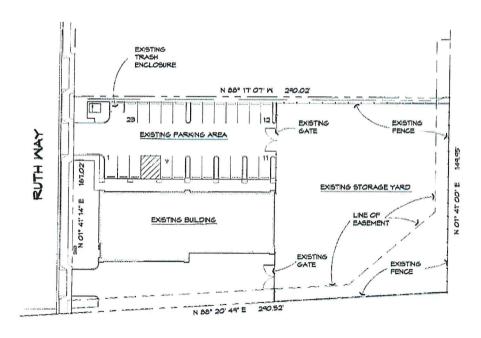


Figure 3: Parcel and Site Dimensions

Road access and street improvements

Access to the business is via Ramada Drive along US Highway 101, east on Cow Meadow Pl and South on Ruth Way. The road is paved the entire way from Ramada Drive.

Buildings and Structures

The building located at 3990 Ruth Way was built in 2006 and is in excellent condition. The applicant currently leases Suite D on the second floor, representing 2,350 square feet of space. The applicant intends to utilize approximately 1,500 square feet of this space as testing space, with the remaining 850 square feet as office and kitchen space.

Easements

Line of Easement for parcel 040-151-063 is shown in the Site Plan and should not impact operations under this Minor Use Permit.

Utilities

Templeton Community Services District provides the water supply and sewer services for the building.

Site Improvements

Location and dimensions of existing parking areas is shown in **Figure 3**. The parking lot material is asphalt and concrete. The building has conforming landscape in place, as shown in **Figure 3** and **Figure 4**.



Figure 4: Existing Landscaping

Landforms

No major topographic or man-made features on the site.

Combining designation

Does not apply, site is not in a combined designation area.

Drainage Plan

This Minor Use Permit does not require a Drainage Plan due to the following:

- 1. No changes expected for runoff volume or velocity leaving any point of the site beyond those that existed prior.
- 2. Does not involve ANY new land disturbance
- 3. Does not result in an impervious surface of more than 20,000 square feet
- 4. Is **NOT** subject to local ponding
- 5. The parcel is located in an MS4 Area. During previous commercial operations as an office, the Public Works Director did not identify this area as having a history of flooding or erosion that was further aggravated by or had a harmful effect on operations or adjoining properties. No site disturbance occurs under this Minor Use Permit and therefore there are no material changes to how Public Works views this project from a historical perspective.
- 6. Parcel is not located within a Flood Hazard (FH) combining designation
- 7. Parcel is not located over a known high recharge area
- 8. Does not involve ANY land disturbance and is not located within 100 feet of the top bank of any watercourse shown with blue line on the most current USGS 7.5 minute quadrangle map
- 9. Project topography does not contain any grade steeper than 10%
- DOES NOT alter existing drainage, cause an on-site erosion or inundation hazard, or change the off-site
 drainage pattern, including, but not limited to any change in the direction, velocity, or volume of flow.

Fire Safety Plan

To be established with Templeton Fire District

Grading Plan

No grading is planned under this permit and therefore a grading permit is not required.

Erosion and Sedimentation Control Plan

Projects exempt from grading permit submittal are not required to prepare an erosion and sedimentation control plan. This project also qualifies as exempt as no site disturbances would occur under this permit.

Community Plan/Specific Plan/Design Plan

NA

Planning Area Requirements

Topic	Standard	Standard Proposed	
Allowable	Land Uses, Permit Requirement		
	"Cannabis Testing" is an allowed use in the Commercial Services land use category. A Minor Use Permit is required.	MUP Application submitted	Yes
General Pr	operty Development Standards		
Location	Cannabis testing facilities shall not be located within six hundred (600) feet from any pre-school, elementary school, junior high school, high school, library, park, playground, recreation or youth center, licensed drug or alcohol recovery facility, or licensed sober living facility. Distance shall be measured from the structure that contains the dispensary to the property line of the enumerated use using a direct straight-line measurement.	Facility is not located within 600ft of sites listed in 22.40.080.D.1	Yes
Setbacks	Setbacks are required as set forth in Section 22.10.140.	Operation is located in existing building	Yes

Table 2: Planning Area Requirements

Sign Information (location, size, design and copy shall be provided)

Signage for the testing facility will be minimal. A decal on the glass entrance door to Suite D will indicate the lab name and phone number (Office Land Line TBD). The decal signage will be similar to Figure 5.

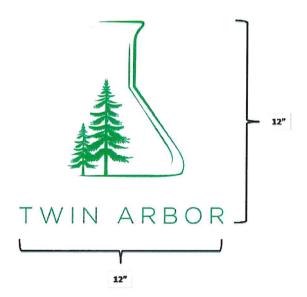


Figure 5: Entrance Door Signage

Tree locations (locations, 8" or larger diameter

All trees on property are less than 8" in diameter. These are listed in the tree inventory in **Table 1** and the locations are shown in **Figure 6**.

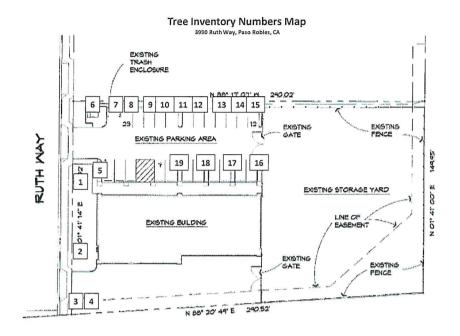


Figure 6: Tree Locations

Ownership Authorization/Verification Form Owner consent form found in Minor Use Permit General Application.

Preliminary Floor Plan

The Preliminary Floor Plan for the lab is shown below in **Figure 6**. A more detailed floor plan is included in the Site Plan packet. Indicated Areas: (1) Main Laboratory, (2) Sample Prep Room, (3) Secured Storage/Storage, (4) Kitchen and Employee Lounge/Office

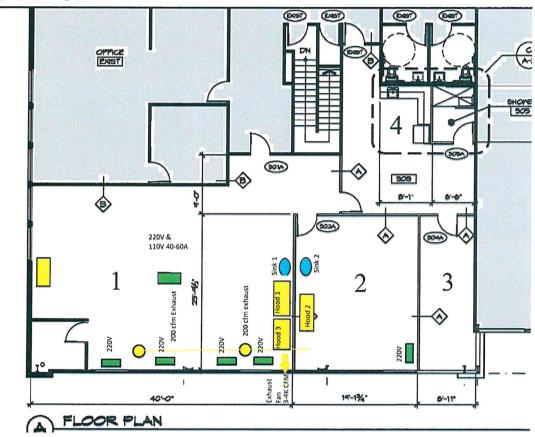


Figure 6: Preliminary Floor Plan

Architectural elevations

NA

Adjacent Land Use Information

Building north of lab – dimensions (google earth) and use (commercial services, type of business needed) Businesses in 3990 Ruth Way:

- 1. Clever Concepts Inc, Address, Business Type/Use
- 2. Warehouse Area / Vineyard Professional Services

Landscape Plan

The Site has existing landscaping. See Landscape Plan.

Contour Map

See figure 7 below.

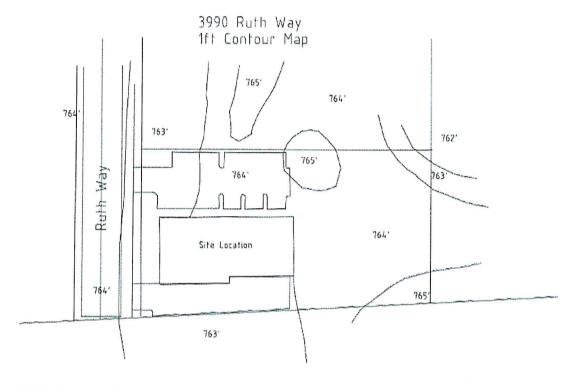


Figure 7: Two Feet contour map

Supplementary Development Statement

300 ft Parcel Map

A list of names and addresses of all owners of real property within 300 feet as shown on the latest equalized assessment role, and residents within 100 feet of the perimeter of the parcel to be developed. This list shall be typed on gummed labels.

Security Plan

The applicant has enlisted SecurePro (Figure 8), a security system installation firm specializing in Cannabis Security systems to install a sufficient system in accordance with state regulations. The laboratory will have both video surveliance and recording systems, as well as an Alarm and Monitoring System and Service provided by SecurePro.

SeourePRO, Inc. 119 N Milpas St Santa Barbara, CA 93103 (P) (805) 880-1200 (F) (888) 701-8105



Estimate #: 10447 Customer # 21422795

License #018 994829, ACO 7328, LGO 6943 & PPO 17734

www.secureproinc.com

Customer	Service Location
Twin Arbor Analytical	3990 Ruth Way, Unit D
3990 Ruth Way, Unit D	Paso Robles, Ca 93446
Paso Robles, Ca 93446	

Iter	n(s)					
Qty	Name	Description	Rate	Amount	Tax	Approved
1	VS: VS- NVR- 16IP-4HD	Network Video Recorder - 16 Camera Support - 4 HD Bays PoE	\$795.00	\$795.00	Tax	Yes
4	VS: VS- HD-8TB	Hard Drive - Video - STB	\$326.00	\$1,300.00	Tax	Yes
11	CAM: VS- EIPT- HDIR-4M	IP Turret Camera - Interior/Exterior IP86, 4MP High Definition and Night Vision Matrix IR LED Resolution 2688 x1536 2.8 mm fixed lens	\$205.00	\$2,255.00	Tax	Yes
1	ups	Battery Back Up	\$109.99	\$109,99	Non	Yes
1	MISC	Mounting hardware, conduit, cable, fasteners, connectors, miscellaneous hardware	\$125.00	\$125,00	Tax	Yes
12	LABOR	Labor - Installation and adjustment of cameras, network video recorder, cabling, network hardware, configuration and set up, testing, instruction, app set up on devices as needed	\$100.00	\$1,200.00	Non	Yes

Subtotal \$5,784.99 Tax \$346.81 Total \$6,131.80

Figure 8: Estimate for security plan

Operations Plan

Operations will be conducted at 3990 Ruth Way Ste. D, Paso Robles, CA 93446 during normal business hours. The laboratory is separated into active laboratory space and office space with approximately 1,500 being dedicated for active laboratory work space.

Parking Plan

Parking is non-assigned in accordance to the lease. The laboratory is expected to have 4 full time employees. Since sample collection is to be conducted by laboratory personnel we expect little customer traffic and a decreased need for customer parking. Our current parking conditions are adequate for the expected customer and employee requirements.

Sample Collection

Samples will be collected by a trained and certified employee. Samples shall be sampled in accordance to BCC regulations. All samples are to be vacuumed sealed in tamper evident bags with corresponding lab file number and chain of custody documents. All incoming samples will be stored in a secure location until processing.

Odor Control Plan

Sample processing will occur in the laboratory sample prep room. This room will have a negative air pressure to assure no odor is released to the outside environment. Air exiting the sample prep room will be scrubbed by a carbon scrubber through the exhaust vent to prevent the release of odor to the environment. Unused sample material will be vacuumed sealed for storage. All samples will be stored in a secure location with access only to laboratory personnel.

Waste management

The laboratory will have two hazardous waste streams categorized as flammable liquids and heavy metal waste with each waste stream generating less than 27 gallons per month. The lab will be classified as a conditionally exempt small quantity generator (CESQG).

The laboratory shall register with the Department of Toxic substances Control (DTSC) and obtain an EPA ID number for the disposal of hazardous waste. Hazardous waste will be disposed through the San Luis Obispo Integrated Waste Management Authority (IWMA).

Cannabis samples will be disposed of after 45 days of sample holding in accordance with BCC regulations.

Materials plan

Hazardous material will be stored in designated locations. All hazardous materials will be below the minimum reportable quantities. Non-compatible substances will be segregated and safely stored. Compressed gasses are to be safely secured and labeled. All materials locations will be properly marked for easy recognitions. Flammable liquids shall be stored in a flammable safety cabinet. Corresponding safety data sheets (SDS) are available for all material stored on site.

Parcel Summary Report

APN: 040-153-018

Parcel Information

APN: 040-153-018

Assessee: POKRAJAC NICHOLAS E TRE ETAL

Care Of:

Address: 2000 LOOKOUT DR TEMPLETON

CA 93465

Description: PM 75/79-80 PAR 2

Site Address: 03990 RUTH WY

Tax Rate Area Code:126028Estimated Acres:1.04Community Code:TEMPSupervisor District:Supdist 1

Avg Percent Slope: 1





Selected Parcel

Land Uses	Combining Designations	
CS		
CJ		



Parcel location within San Luis Obispo County

Permit Information

Permit DRC2018-00151	Description Land Use	Application Date 8/28/2018 9:53:32 AM
PMT2012-00536	PMTC - Commercial Permit	9/20/2012 3:18:59 PM
SUB2011-00039	Subdivision	3/27/2012 3:41:32 PM
ZON2007-00066	Zoning Clearance	7/27/2007 4:21:07 PM
PMT2005-03056	PMTC - Commercial Permit	4/14/2006 4:07:19 PM



Parcel Summary Report APN: 040-153-018

DRC2005-00101	Land Use	12/1/2005 9:41:06 AM
SUB2004-00070	Subdivision	8/19/2004 12:00:00 AM
PMT2003-02285	PMTC - Commercial Permit	1/23/2004 12:00:00 AM
PMT2002-13450	PMTG - Grading Permit	9/12/2002 12:00:00 AM
PMT2002-13448	PMTC - Commercial Permit	9/12/2002 12:00:00 AM
S010223N	Subdivision	2/8/2002 12:00:00 AM
PMT2002-12402	PMTC - Commercial Permit	2/6/2002 12:00:00 AM
G000017F	Long Range Planning	3/8/2001 12:00:00 AM
D000174S	Land Use	11/16/2000 12:00:00 AM
C0334	PMTG - Grading Permit	6/7/2000 12:00:00 AM
S990306Q	Subdivision	5/12/2000 12:00:00 AM
S850009C	Subdivision	5/3/1998 12:00:00 AM
S880136T	Subdivision	3/10/1998 12:00:00 AM

Clerk Recorder Documents

Clerk Document	Date	Document Type
2014-I-002858	10/06/2014	С



Interactive Data Viewer



Legend

- SLO County Parcels
 Roads
 - CalTrans
 - Maintained by SLO CO
 - Private Maintenance
 - Federal or State Maintenance


REFERRAL -- Page 23 of 50

-188.08 0 94.04 188.08 Feet 1: 1,128




The County of San Luis Obispo does not assume liability for any damages caused by errors or omissions in the data and makes no warranty of any kind, express or implied, that these data are accurate and reliable.

Map for Reference Purposes Only

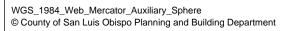



Interactive Data Viewer

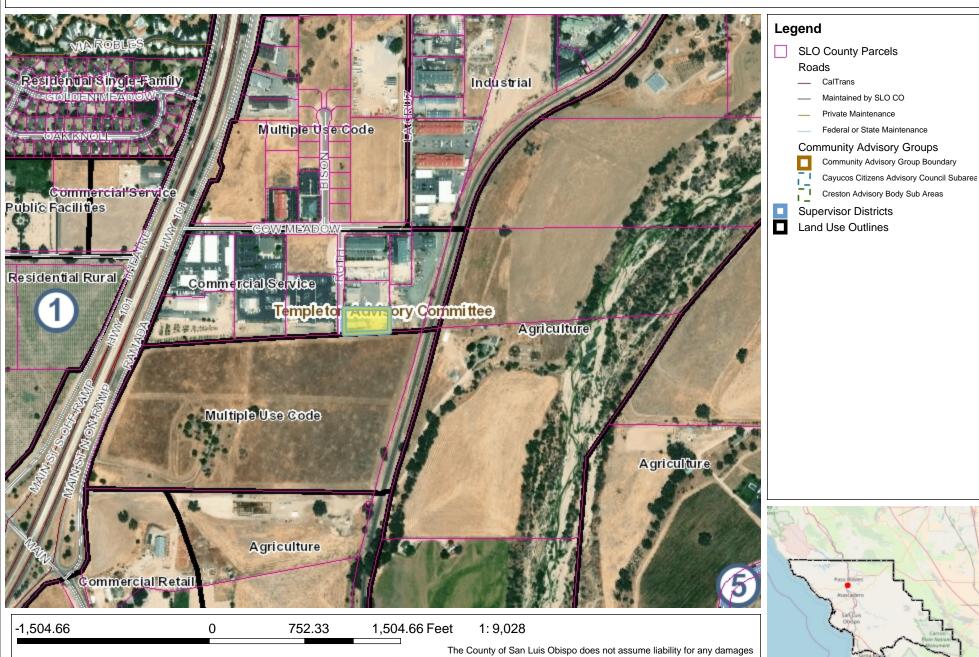


The County of San Luis Obispo does not assume liability for any damages caused by errors or omissions in the data and makes no warranty of any kind, express or implied, that these data are accurate and reliable.


Map for Reference Purposes Only


REFERRAL -- Page 24 of 50

WGS_1984_Web_Mercator_Auxiliary_Sphere
© County of San Luis Obispo Planning and Building Department



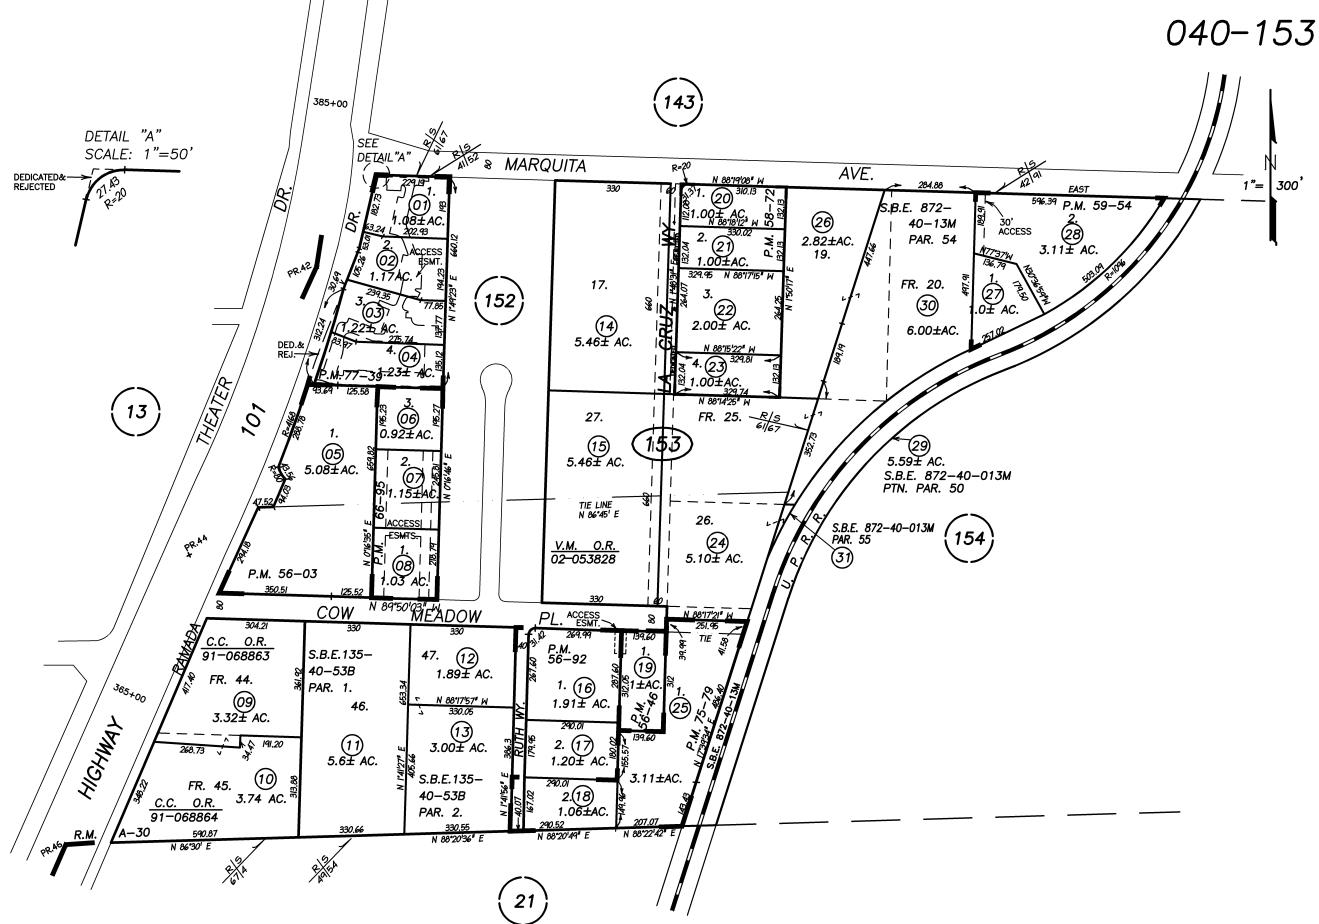

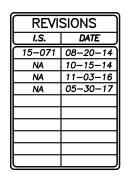

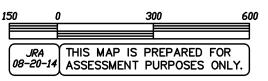


TEMPLETON

ASSESSER SL MARIE COUNTY OF SAN LUIS OBISPO, CA.
BOOK 040 PAGE 153

Crizer Design Company, Inc. P.O. Box 6952 Los Osos, CA 93412 Ph. (805)528-4812 Fax 528-2325


Date: $\begin{array}{c} 6/26/18\\ \text{Scale:} 1/16''\\ \text{Drawn By:} \\ \text{Sht.} \\ C-1 \end{array}$

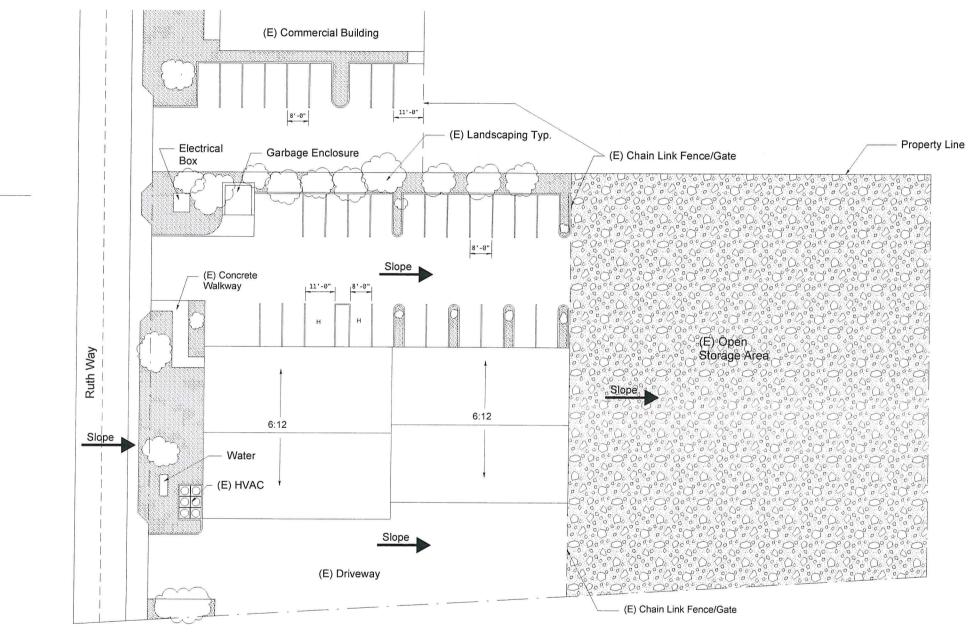

Ceiling Legend

Existing, No Change
Exposed to Existing Structure
5/6" Type 1" Gypsum Wallboard
24" x48" Suspended Acoustical Tile, Cirrus Beveled
124" x48" Suspended Acoustical Tile, Cirrus Beveled
Tegular by Armstrong with 15/16 White Suspension
System, Prolude MX by Armstrong (ICBO # 5175) or
Approved Equi.




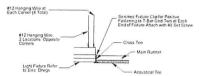

Light Fixture Support Notes

- 2. Suspended ceiling shall comply with CBC tables 25-A and 16-O.

2 Typ. Light Fixture Support

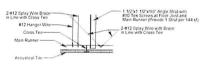

Ceiling Notes


- 2. Spay wire bracing shall be located 12'-0" O.C. max. each way and 4'-0" max. from face of wall.
- 3. All wire shall have 3 tight turns min. around itself.
- 4. Provide 14ga, clips at all intersections and a hanger at each corner of light fixture.
- 5. Suspended ceiling shall comply with CBC tables 25-A and 16-O.

1) Typ. Seismic Brace


Wall Legend Existing Wall to Remain

Wall Types

- A 3-5/8"x22ga MTL Studs @ 16" O.C. with 5/8" Type
 "X"GYP BD Each Side with 3" Sound Atten. Blanket.
 (1-Hour Rated) Full Height.
- B With 5/8" Type 'X' GYP BD One Side on Existing Wall
- C 6"x22ga MTL Studs @ 16" C C with 5/8" Type 'X' GYP B D Each Side with 3" Sound After Blanket Full Height

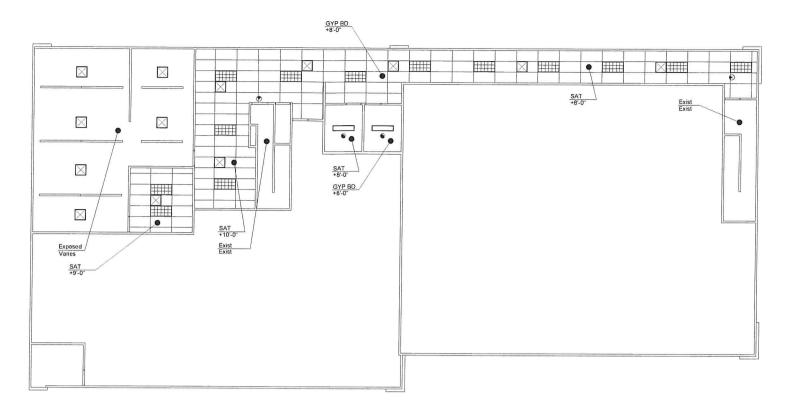

B Reflected Ceiling Plan

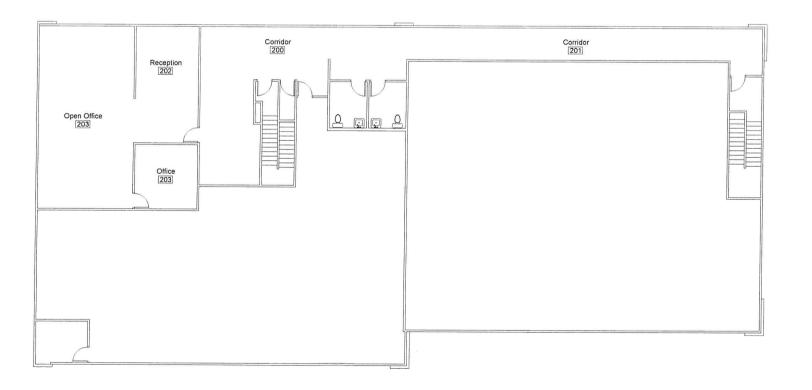

A Floor Plan
Scale 1/8"= 1' 0"

Revisions: <u>Â</u> xx/xx/xx <u>B</u> <u>C</u> /D

Legal Description: APN: 040-151-063 County Of San Luis Obispo


Commercial

Owner/Site Address: 3990 Ruth Way Suite D Paso Robles, CA 93446

Crizer Design Company, Inc. P.O. Box 6952 Los Osos, CA 93412 Ph. (805)528-4812 Fax 528-2325


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RC
Sht. ?


REFERRAL -- Page 27 of 50

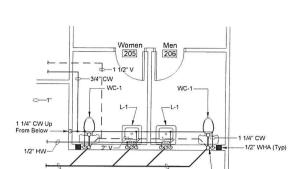

Plumbing Enlarged Floor Plan
Scale 1/4"= 1'0"

						PΙι	ımbing	Fixtur	e S	ch	edı	ule						
Mark Description		intion	Min.	Bran	ch Siz	e (")	Make and Model		Mala and Mala Service						Remarks			
		puon	W	V	CW	HW				Fittings								
L-1	ADA Lavatory Wall Mount		2	1-1/2	1/2	1/2	Kohler "Kingston 21"x18" Vitreous China	*#K2005,	Stops	Symmons Faucet #S-20-2-G-FR-IPS w/ Grid Strainer, Stops, Supplies, and C.P. Brass "P" Trap J.R. Smith Wall Support #0722				See Architec Requirement	tural Drawing for ADA s			
WC-1	ADA Water Cl Floor Mounted Elongated, 1.6	1	3	2	1-1/4	0.—0	Kehler "Highcres 27-5/6" x 14 1/2" Vitreous China		Sloar and C	Sloan Royal Flush Valve #111, and Olsonite Seat #10CC			See Architectural Drawing for ADA Requirements, Flush Valve Actuate to Wide Side of Space					
						V	Vater H	eater	Sch	nec	lule	9						
Mark	Make	Model		age	Dime		Full	Inlet/	Р	owe	r		MBTUH	Branch Size	Flue	Remarks		
Widne	Make	Wiodei	(Gal		Dirilei	131011	(Pounds)	(Inches)	Volts	РН	CY	KVV		(Inches)		Remarks		
WH-1	A.O. Smith	DEL-10	1	0	18-1/4"x18"ø		18-1/4"x18"ø		135	3/4"	120	1	60	1.5	-	_	_	Provide with Smitty Drai Pan Attach to Wall of Approved Seismec Restraint Spacemaker #TSE-25

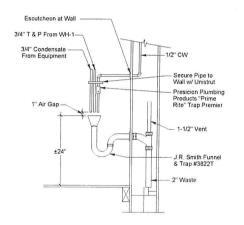

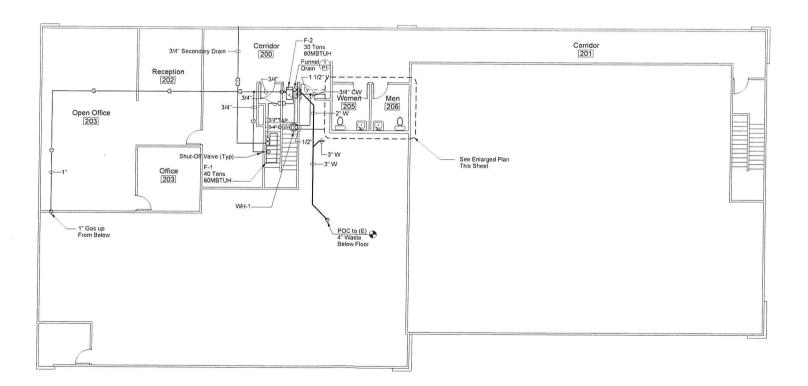

Plumbing Second Floor Plan
Scale 1/8"= 1' 0"

Legal Description: APN: 040-151-063 County Of San Luis Obispo

Commercial

Owner/Site Address: 3990 Ruth Way Suite D Paso Robles, CA 93446

Crizer Design Company, Inc. P.O. Box 6952 Los Osos, CA 93412 Ph. (805)528-4812 Fax 528-2325

Date: 6/26/18 Scale: 1/8" Drawn By:
RC
Sht. ?


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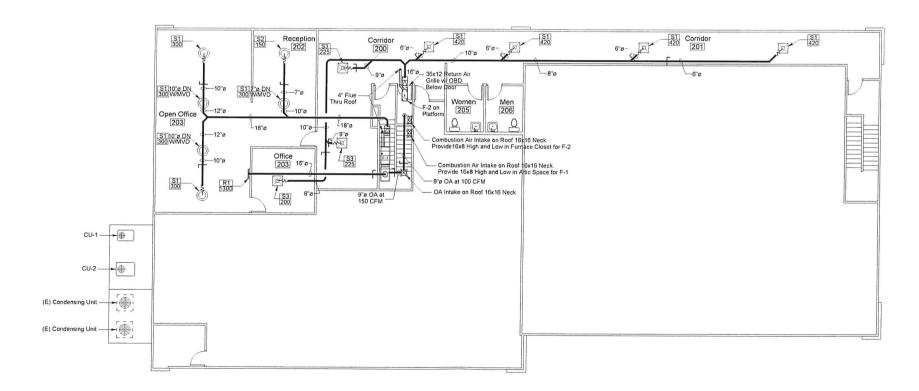
Commercial

Owner/Site Address: 3990 Ruth Way Suite D Paso Robles, CA 93446

Crizer Design Company, Inc. P.O. Box 6952 Los Osos, CA 93412 Ph. (805)528-4812 Fax 528-2325





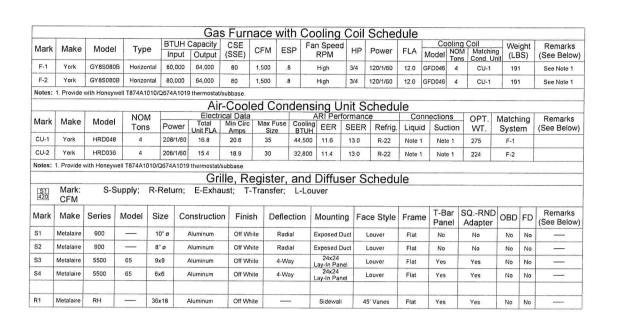


B Mechanical Second Floor Plan
Scale 1/8"= 1' 0"

Ceiling Legend

Existing, No Change
Exposed to Existing Structure
5/6* Type 'x Gypsum Wallboard
24* 486* Suspended Acoustical Tie, Cirrus Beveled
Tepular by Amsterong with 15-16 White Suspension
System, Prelude MX by Amstrong (ICBO # 5175) or




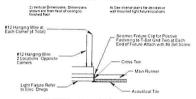

Light Fixture Support Notes

- 1. All wire shall have 3 tight turns minimum around itself.
- 2. Suspended ceiling shall comply with CBC tables 25-A and 16-O.

Typ. Light Fixture Support

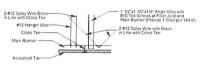

Ceiling Notes

- Hanger wire shall be located 4'-0" O.C. max. and 8" max. from face of wall.
- 2. Spay wire bracing shall be located 12'-0" O.C. max. each way and 4'-0' max. from face of wall.
- 3. All wire shall have 3 tight turns min. around itself.
- 4. Provide 14ga. clips at all intersections and a hanger at each corner of light fixture.
- 5. Suspended ceiling shall comply with CBC tables 25-A and 16-O.

1) Typ. Seismic Brace

Wall Legend


Existing Wall to Remain

Wall Types


- A 3-5/8"x22ga MTL Studs @ 16" O.C. with 5/8" Type
 "X" GYP. BD Each Side with 3" Sound Atten Blanket
 (1-Hour Rated) Full Height
- B With 5/8" Type 'X' GYP BD One Side on Existing Wall

Stair Notes

- All stairs shall have 1 1/2" O.D. max. handrails each side of stair mounted at 34" above stair nosings.
- Handrails shall extend 12" beyond the top riser and 24" beyond the bottom riser.
- Handrails shall be smooth with the ends returned or shall have rounded terminations or bends.
- Handrails shall not project more than 3" from the wall and have a space between the handrail and the wall of not less than 1 1/2".
- All edges of treads shall be free from sharp objects and have smooth, rounded edges.
- G. Nosings shall not project more than 1 1/2" past the face of the riser.
- 7. Provide a 2" wide slip resistant color contrasting warning strip parallel to and not more than 1" from the step nosing, strip to be replaced on the upper tread and lower tread of each stair run.

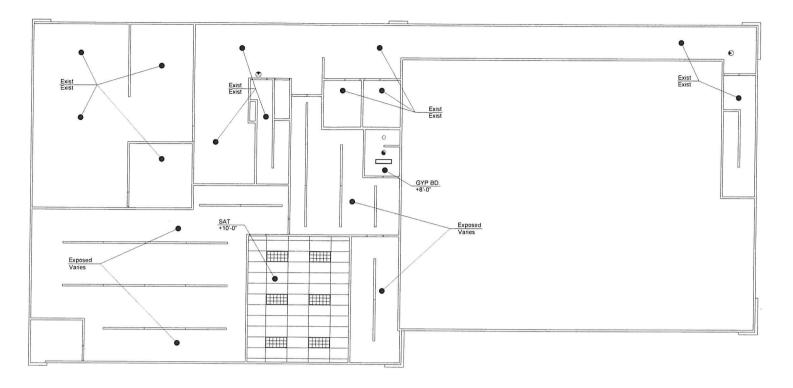

B Reflected Ceiling Plan

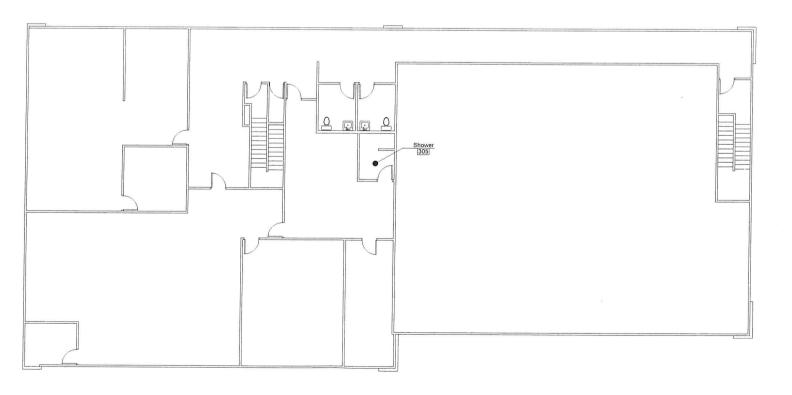

A Floor Plan
Scale 1/8"= 1'0"

Revisions: $\hat{\mathbf{A}}_{XX/XX/XX}$

Legal Description: APN: 040-151-063 County Of San Luis Obispo

Commercial


Owner/Site Address: 3990 Ruth Way Suite D Paso Robles, CA 93446

Crizer Design Company, Inc. P.O. Box 6952 Los Osos, CA 93412 Ph. (805)528-4812 Fax 528-2325

Date: 6/26/18 Scale: 1/8" Drawn By: RC Sht. ?

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Ceiling Legend

Existing, No Change
Exposed to Existing Structure
5/8" Type' x' Gypsum Wallboard
24" x48" Supended Acoustical Tile, Cirrus Beveled
Tegular by Armstrong with 15/16 White Suspension
System, Predude MX by Armstrong (ICBO # 5175) or
Approved Equal

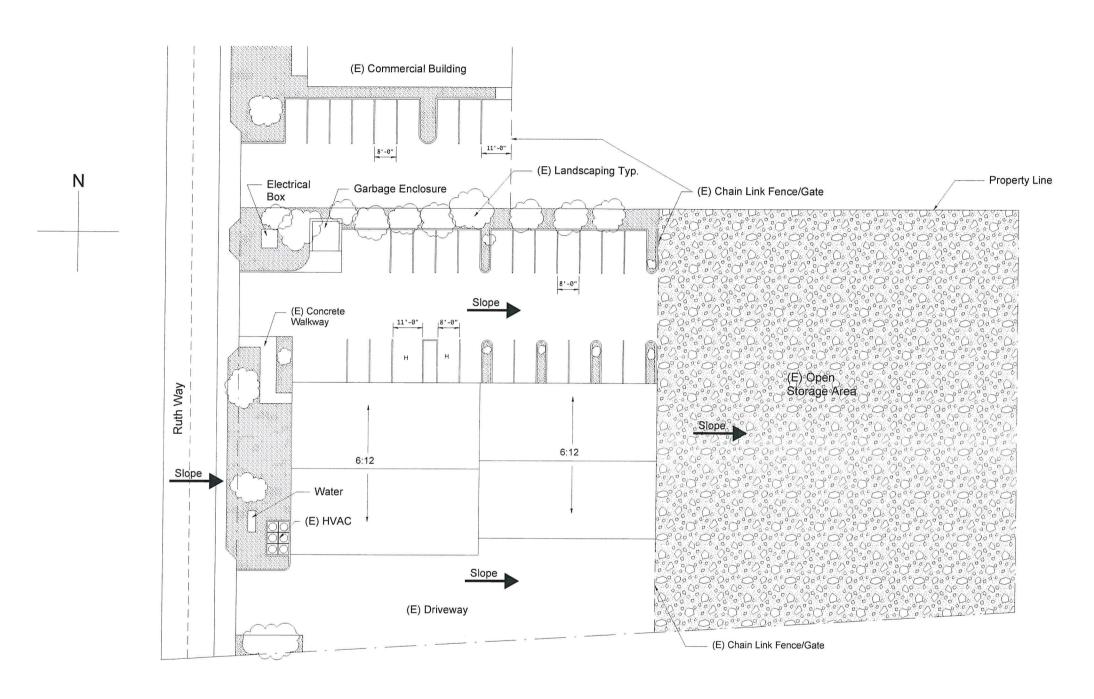


SPE County Comma Manage World World Louising Co. Co.A. Decorative indirect Light Future

Decorative indirect Light Future

Decorative indirect Light Future


 Horizontal Dimensions All dimensions Shown are from face of study, face of concrete centered between walls/beams unless or face of C M U unless otherwise noted otherwise noted. 21 Vertical Dimensions Dimensions 43 See interior plans for decorative shown are from face of ceding to wall mounted light 8 sture locations fevired floor.

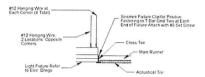

Light Fixture Support Notes

- 1. All wire shall have 3 tight turns minimum around itself.
- 2. Suspended ceiling shall comply with CBC tables 25-A and 16-O.

2 Typ. Light Fixture Support

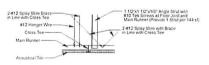

Ceiling Notes

- Hanger wire shall be located 4'-0" O.C. max. and 8" max. from face of wall.
- 2. Spay wire bracing shall be located 12'-0" O.C. max. each way and 4'-0" max. from face of wall.
- 3. All wire shall have 3 tight turns min. around itself.
- 4. Provide 14ga. clips at all intersections and a hanger at each corner of light fixture.
- 5. Suspended ceiling shall comply with CBC tables 25-A and 16-O.


1) Typ. Seismic Brace

Wall Legend


Existing Wall to Remain

Wall Types

- A 3-5/8"x22ga MTL Studs @ 16" O C with 5/8" Type
 "X"GYP BD. Each Side with 3" Sound Atten Blanket
 (1-Hour Rated) Full Height
- B With 5/8" Type 'X' GYP BD One Side on Existing Wall
- 6"x22ga MTL Studs @ 16" O.C. with 5/8" Type 'X' GYP B.D. Each Side with 3" Sound After, Blanket Full Height

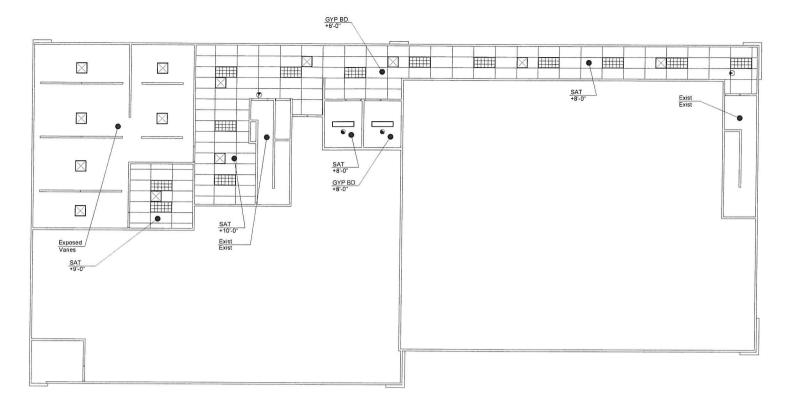

B Reflected Ceiling Plan
Scale 1/8"= 1' 0"

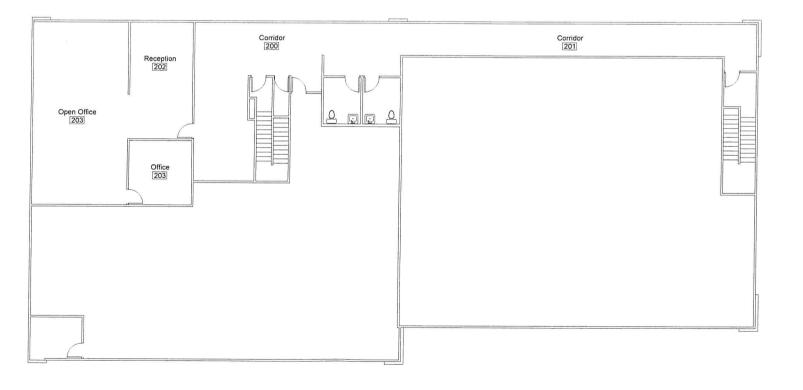

A Floor Plan
Scale 1/8"= 1'0"

Revisions: A XX/XX/XX <u>B</u> <u>C</u> <u>D</u>

Legal Description: APN: 040-151-063 County Of San Luis Obispo

Commercial

Owner/Site Address: 3990 Ruth Way Suite D Paso Robles, CA 93446

Crizer Design Company, Inc. P.O. Box 6952 Los Osos, CA 93412 Ph. (805)528-4812 Fax 528-2325

6/26/18 Scale: 1/8" Drawn By: RC Sht. ?


REFERRAL -- Page 32 of 50



Legal Description: APN: 040-151-063 County Of San Luis Obispo


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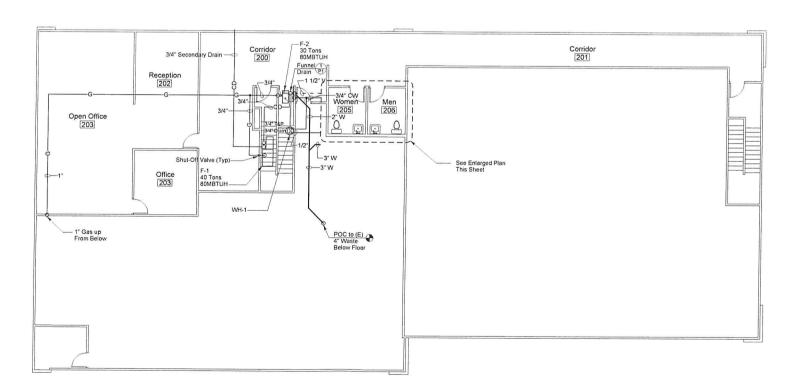


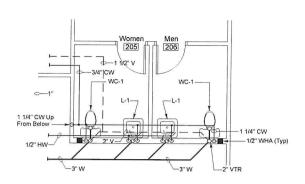

Plumbing Enlarged Floor Plan Scale 1/4"= 1' 0"

						Plu	ımbing	Fixtur	e S	ch	ed	ule							
Mark Description		Min. Branch		ch Siz		1													
Walk	Desci	puon	W	V	CW	HW	Make and Model Fittings		Make and Model Fittings Re		marks								
L-1	ADA Lavatory Wall Mount		2	1-1/2	1/2	1/2	Kohler "Kingstor 21"x18" Vitreous China	*#K2005,	Stops	Symmons Faucet #S-20-2-G-FR-IPS w/ Grid Strainer, Stops, Supplies, and C.P. Brass *P* Trap J.R. Smith Wall Support #0722				See Architec Requirement	tural Drawing for ADA s				
WC-1	ADA Water C Floor Mounted Elongated, 1.6	1	3	2	1-1/4				27-5/8" x 14 1/2" x 16 1/2" RIM, and Olsonite Seat #10CC Requ								Requirement	hitectural Drawing for ADA ments. Flush Valve Actuator Side of Space	
						V	Vater H	eater	Sch	nec	dule	Э							
Mark	Make	Model		rage	Dimo	ocion	Full S Weight	Inlet/ Outlet	Р	owe	r	KIN	MOTUL	Branch	Flue	D			
WIGH	Wake	woder	(Gal		Dillie	151011	(Pounds)	(Inches)	Volts	РН	CY	KW MBTUH		Size (Inches)	Size (Inches)	Remarks			
WH-1	A.O. Smith	DEL-10	1	0	18-1/4"x18"ø		18-1/4"x18"ø		135	3/4"	120	1	60	1.5	1-1	_	_	Provide with Smitty Drain Pan. Attach to Wall W Approved Seismec Restraint Spacemaker #TSE-25	



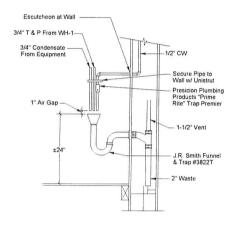


Plumbing Second Floor Plan Scale 1/8"= 1'0"


Commercial

Owner/Site Address: 3990 Ruth Way Suite D Paso Robles, CA 93446

Crizer Design Company, Inc. P.O. Box 6952 Los Osos, CA 93412 Ph. (805)528-4812 Fax 528-2325



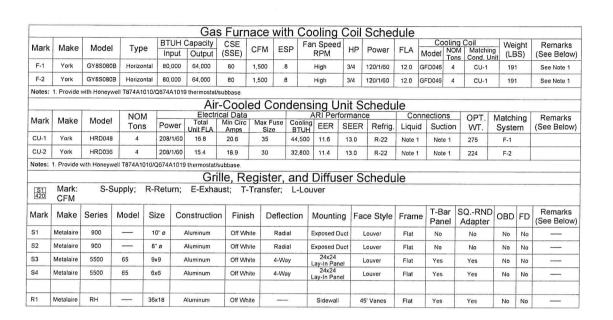

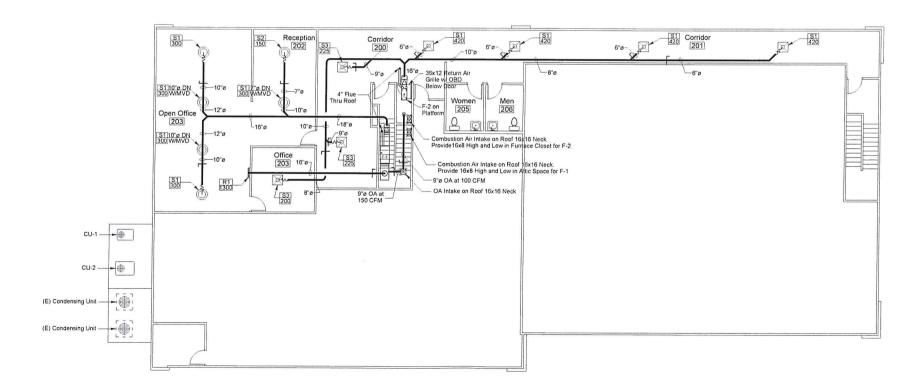

B Mechanical Second Floor Plan

Ceiling Legend

Existing, No Change
Exposed to Existing Structure
5/6* Type ** (Gypsum Wallboard
24* x4* Suspended Acoustical Tile, Cirrus Beveled
Tegular by Amstrong with 15/16 White Suspension
System, Prelude MX by Armstrong (ICBO # 5175) or
Approved Equal

Ceiling Fixture Legend & Notes 2"x4" Fluorescent Light Fixture }- Side Walt Diffuser

2"x2" Fluorescent Light Fixture \(\times \) Supply Air Diffuser 27x2* Fluorescent Light Fixture X Supply Air Diffuser Cove Light w/ Strip Flourescent Return Air Grite Track Light Fixture _____ Decorative Ceiling Mounted Fixture Illuminated Exit Sign O Recessed Light Fixture Security Camera ✓ Wall Mounted Uplight SM Security Comercial Security Country (Security Comercial Security Co Decorative Indirect Light Fixture

Television, Mount @ 8:6" A P P Horizontal Dimensions All dimensions shown are from face of Study. Face of concrete, or face of St. M. U unless otherwise noted crete with the state of the


2) Vertical Dimensions Dimensions 4) See interior plans for decorative shown are from face of ceiling to minshed floor. Wall mounted light fixture locations finished floor. #12 Hanging Wire at _ Each Corner (4 Total) Light Fixture Refer ____ to Elec Drwgs

Light Fixture Support Notes

1. All wire shall have 3 tight turns minimum around itself.

2. Suspended ceiling shall comply with CBC tables 25-A and 16-O.

2 Typ. Light Fixture Support

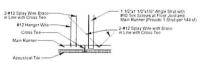

Ceiling Notes

Hanger wire shall be located 4'-0" O.C. max. and 8" max. from face of wall.

2. Spay wire bracing shall be located 12'-0" O.C. max. each way and 4'-0" max. from face of wall.

3. All wire shall have 3 tight turns min, around itself.

Provide 14ga. clips at all intersections and a hanger at each corner of light fixture.

5. Suspended ceiling shall comply with CBC tables 25-A and 16-O.

1) Typ. Seismic Brace

Wall Legend

Existing Wall to Remain

Wall Types

A 3-5/8"x22ga MTL Studs @ 16" O C with 5/8" Type
'X' GYP BD. Each Side with 3" Sound Atten Blanket
(1-Hour Rated) Full Height

B With 5/8" Type 'X' GYP BD One Side on Existing Wall

Stair Notes

All stairs shall have 1 1/2" O.D. max. handrails each side of stair mounted at 34" above stair nosings.

Handrails shall extend 12" beyond the top riser and 24" beyond the bottom riser.


Handrails shall be smooth with the ends returned or shall have rounded terminations or bends.

Handrails shall not project more than 3° from the wall and have a space between the handrail and the wall of not less than 1.1/2°.


5. All edges of treads shall be free from sharp objects and have smooth, rounded edges.

Nosings shall not project more than 1 1/2" past the face of the riser.

7. Provide a 2° wide slip resistant color contrasting warning strip parallel to and not more than 1° from the step nosing, strip to be replaced on the upper tread and lower tread of each stair run.

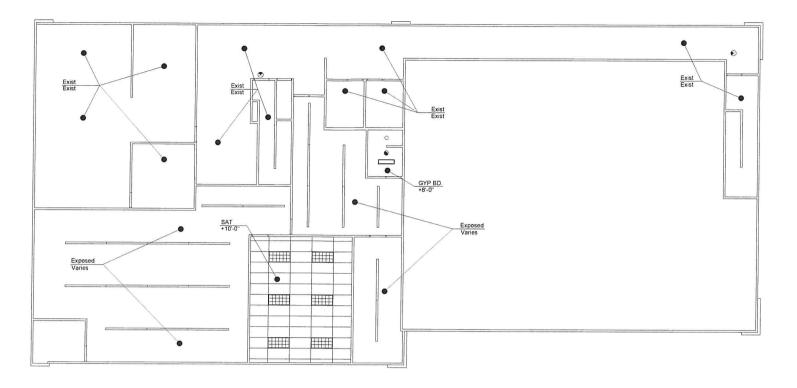

B Reflected Ceiling Plan

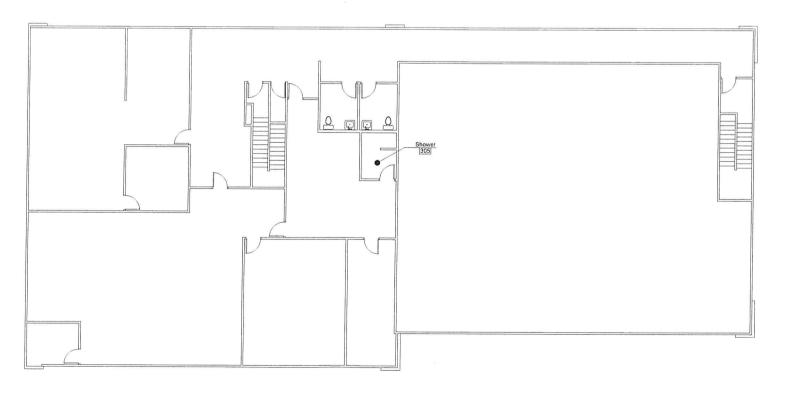

A Floor Plan
Scale 1/8"= 1' 0"

Revisions: A xx/xx/xx /D

Legal Description: APN: 040-151-063 County Of San Luis Obispo

Commercial

Owner/Site Address: 3990 Ruth Way Suite D Paso Robles, CA 93446

Crizer Design Company, Inc. P.O. Box 6952 Los Osos, CA 93412 Ph. (805)528-4812 Fax 528-2325

6/26/18 Scale: 1/8" Drawn By: RC Sht. 2

REFERRAL -- Page 35 of 50


Legal Description: APN: 040-151-063 County Of San Luis Obispo

Commercial

Owner/Site Address: 3990 Ruth Way Suite D Paso Robles, CA 93446

Crizer Design Company, Inc. P.O. Box 6952 Los Osos, CA 93412 Ph. (805)528-4812 Fax 528-2325


Date:
6/26/18
Scale: 1/16" Drawn By: C-1

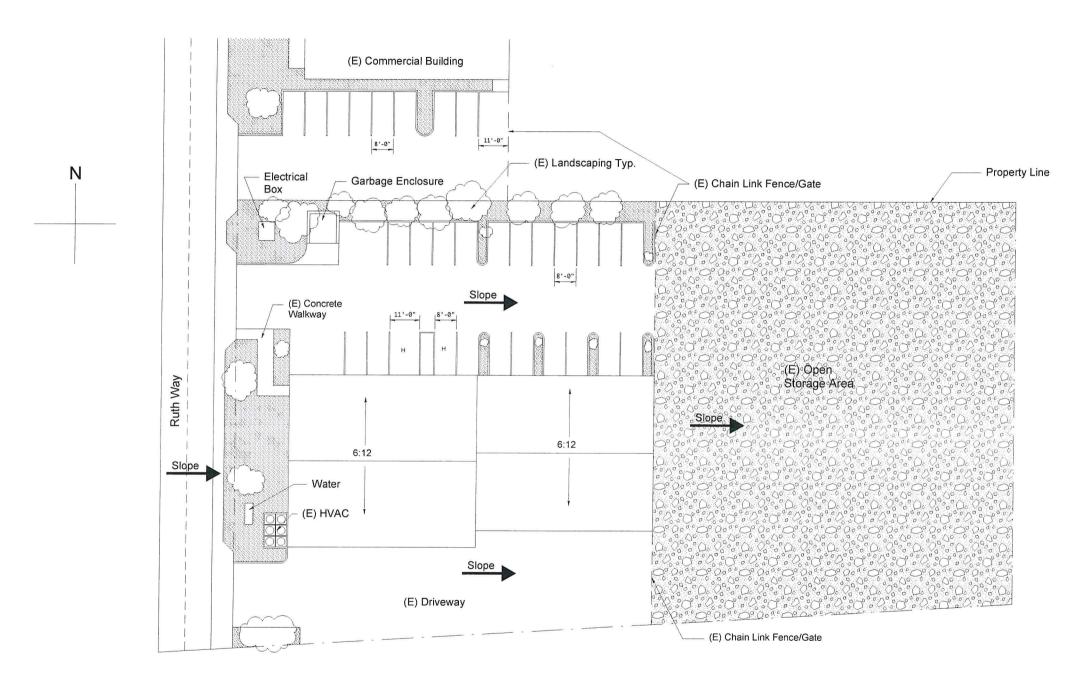

Existing, No Change
Exposed to Existing Structure
5/8" Type 'x' Gypsum Wallboard
24" x48" Supended Acoustical Tile, Cirrus Beveled
Tegular by Armstrong with 15/16 White Suspension
System, Prelude MK by Armstrong (ICBO # 5175) or
Approved Equal

Ceiling Fixture Legend & Notes



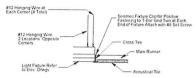


Light Fixture Support Notes

1. All wire shall have 3 tight turns minimum around itself.

2. Suspended ceiling shall comply with CBC tables 25-A and 16-O.

2 Typ. Light Fixture Support

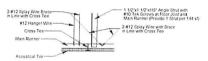

1. Hanger wire shall be located 4'-0" O.C. max. and 8" max. from face of wall.

2. Spay wire bracing shall be located 12'-0" O.C. max. each way and 4'-0" max. from face of wall.

3. All wire shall have 3 tight turns min. around itself.

Provide 14ga. clips at all intersections and a hanger at each corner of light fixture.


5. Suspended ceiling shall comply with CBC tables 25-A and 16-O.

1 Typ. Seismic Brace


Wall Legend

Wall Types

- A 3-5/8"x22ga MTL Studs @ 16" O C with 5/8" Type
 "X" GYP BD Each Side with 3" Sound Atten Blanket
 (1-Hour Rated) Full Height
- B With 5/8" Type 'X' GYP BD One Side on Existing Wall
- C 6"x22ga MTL Studs @ 16" O.C. with 5/8" Type "X" GYP B.D. Each Side with 3" Sound Atten. Blanket Full Height

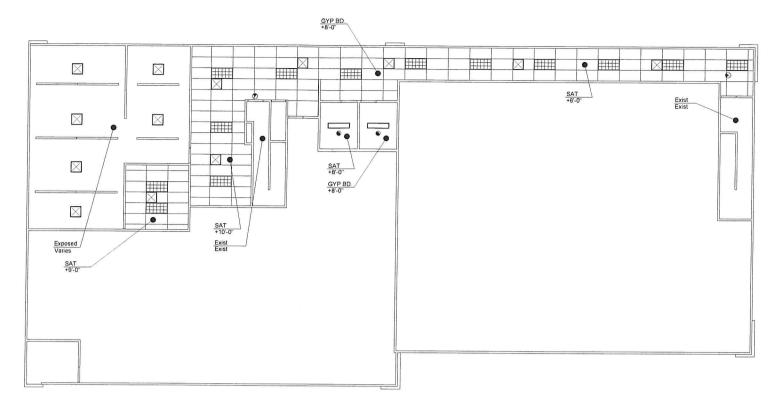

B Reflected Ceiling Plan
Scale 1/8"= 1'0"

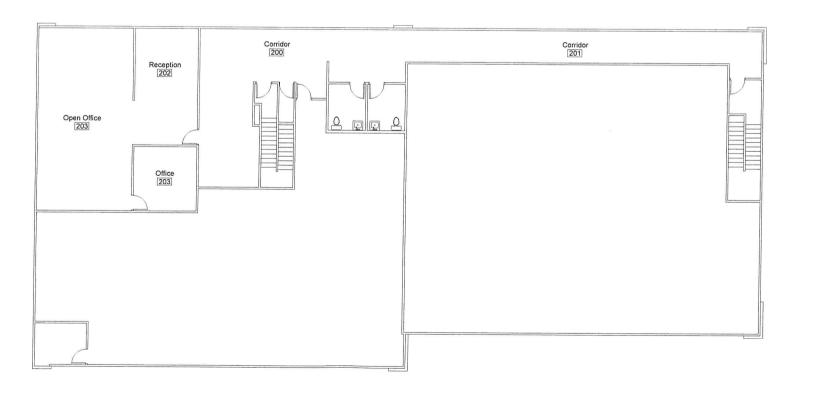

A Floor Plan
Scale 1/8"= 1' 0"

Revisions: A xx/xx/xx B C C D

Legal Description: APN: 040-151-063 County Of San Luis Obispo


Commercial

Owner/Site Address: 3990 Ruth Way Suite D Paso Robles, CA 93446

Crizer Design Company, Inc. P.O. Box 6952 Los Osos, CA 93412 Ph. (805)528-4812 Fax 528-2325


Date: 6/26/18 Scale: 1/8" Drawn By: RC Sht. ?


REFERRAL -- Page 37 of 50

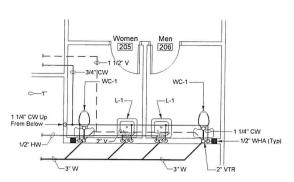

Plumbing Enlarged Floor Plan Scale 1/4"= 1' 0"


						PΙι	ımbing	Fixtu	e S	ch	ed	ule						
Mark Description		Min. Branch Size (")																
IVIGILA	Description		W	V	CW	HW	Make and Model			Fittings						Remarks		
L-1 ADA Lavatory Wall Mount			2	1-1/2	1/2	1/2	Kohler "Kingston" #K2005, 21/st "Kingston" #K2005, Symmons Faucet #S-20-2-G-FR-IPS w/ Grid Strains Stops, Supplies, and Ci.P. Brass "P" Trap J.R. Smith Wall Support #0722				Grid Strainer,	See Architectural Drawing for ADA Requirements						
WC-1	ADA Water Ci Floor Mounted Elongated, 1.6		3	2	1-1/4		Kohler "Higheres 27-5/8" x 14 1/2" Vitreous China		Sloar and C	and Olsonite Seat #10CC					See Architectural Drawing for ADA Requirements. Flush Valve Actuato to Wide Side of Space			
						V	Vater H	eater	Sch	nec	lule	9						
Mark	Make	Model	Stor		Dime	neion	Full S Weight	Inlet/ Outlet	77.75	owe		KVV	MBTUH	Branch Size	Flue	Demade		
mani	mano	Model	(Gall		Dillici	131011	(Pounds)	(Inches)	ches) Volts PH CY		MBTOH		Size (Inches)	Remarks				
WH-1	A.O. Smith	DEL-10	1	0	18-1/4"x18"ø		135	3/4"	120	1	60	1.5		_	-	Provide with Smitty Drain Pan Attach to Wall W/ Approved Seismec Restraint Spacemaker #TSE-25		

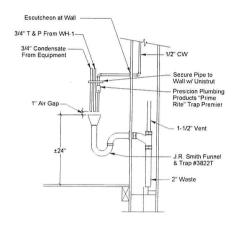


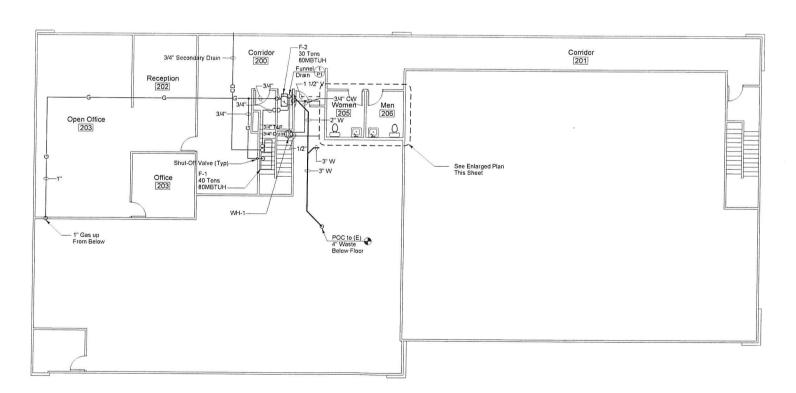

Plumbing Second Floor Plan
Scale 1/8"= 1'0"



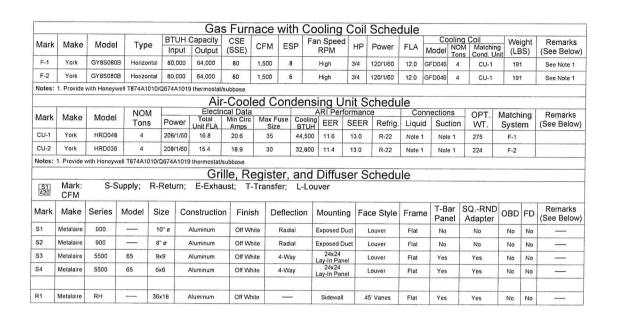

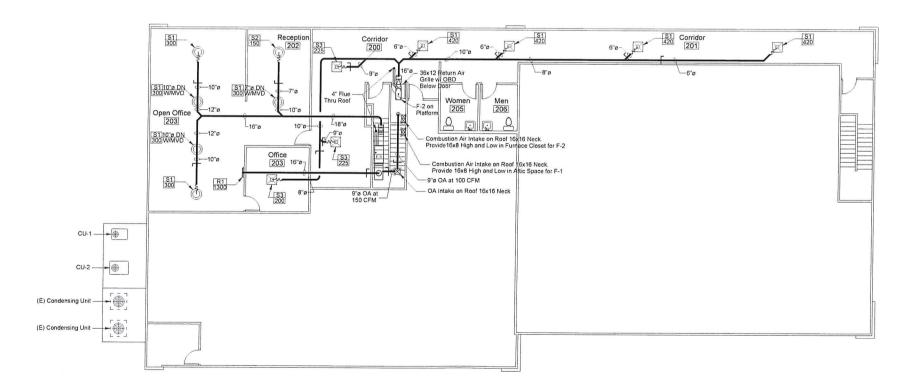


B Mechanical Second Floor Plan
Scale 1/6"= 1'0"

Exist Exposed GB SAT

Existing, No Change
Exposed to Existing Structure
5/0" Type 'x Gypsum Wallboard
24" x48" Suspended Acoustical Tile, Cirrus Beveled
Tegular by Armstrong with 15/16 White Suspension
System, Prelude kKK by Armstrong (ICBO # 5175) or
Approved Equ.




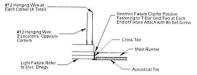

Light Fixture Support Notes

- 1. All wire shall have 3 tight turns minimum around itself.
- 2. Suspended ceiling shall comply with CBC tables 25-A and 16-O.

2 Typ. Light Fixture Support

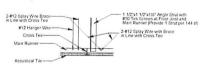

Ceiling Notes

- Hanger wire shall be located 4'-0" O.C. max. and 8" max. from face of wall.
- 2. Spay wire bracing shall be located 12'-0" O.C. max. each way and 4'-0" max. from face of wall.
- 3. All wire shall have 3 tight turns min. around itself.
- Provide 14ga, clips at all intersections and a hanger at each corner of light fixture.
- 5. Suspended ceiling shall comply with CBC tables 25-A and 16-O.

1) Typ. Seismic Brace

Wall Legend

Existing Wall to Remain

Wall Types


- A 3-5/8"x22ga MTL Studs @ 16" O C with 5/8" Type
 'X' GYP BD Each Side with 3" Sound Atten Blanket
 (1-Hour Rated) Full Height
- B With 5/8" Type 'X' GYP BD One Side on Existing Wall

Stair Notes


All stairs shall have 1 1/2" O.D. max, handrails each side of stair mounted at 34" above stair nosings.

- Handrails shall extend 12" beyond the top riser and 24" beyond the bottom riser.

- All edges of treads shall be free from sharp objects and have smooth, rounded edges.
- 6. Nosings shall not project more than 1 $1/2^{\circ}$ past the face of the riser.

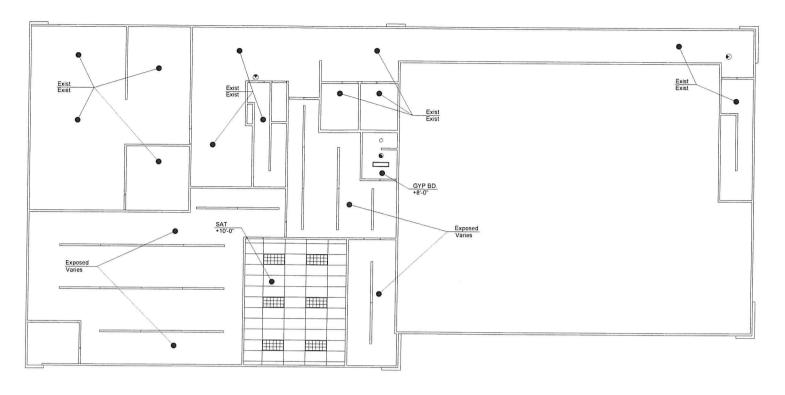

B Reflected Ceiling Plan
Scale 1/8"= 1' 0"

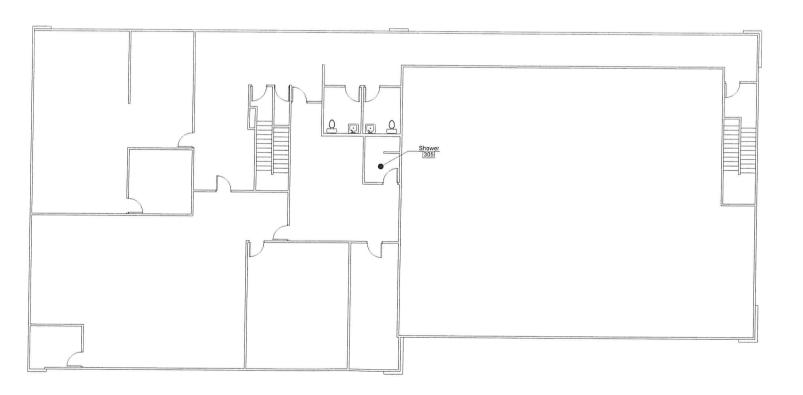

A Floor Plan
Scale 1/8"= 1' 0'

Revisions: A XX/XX/XX /D

Legal Description: APN: 040-151-063 County Of San Luis Obispo


Commercial

Owner/Site Address: 3990 Ruth Way Suite D Paso Robles, CA 93446

Crizer Design Company, Inc. O. Box 6952 Los Osos, CA 93412 (805)528-4812 Fax 528-2325 P.O. Ph. (8

Date: 6/26/18 Scale: 1/8" Drawn By: RC Sht. ?


Date:
6/26/18
Scale:
1/16"
Drawn By:
RC
Sht.
C-7

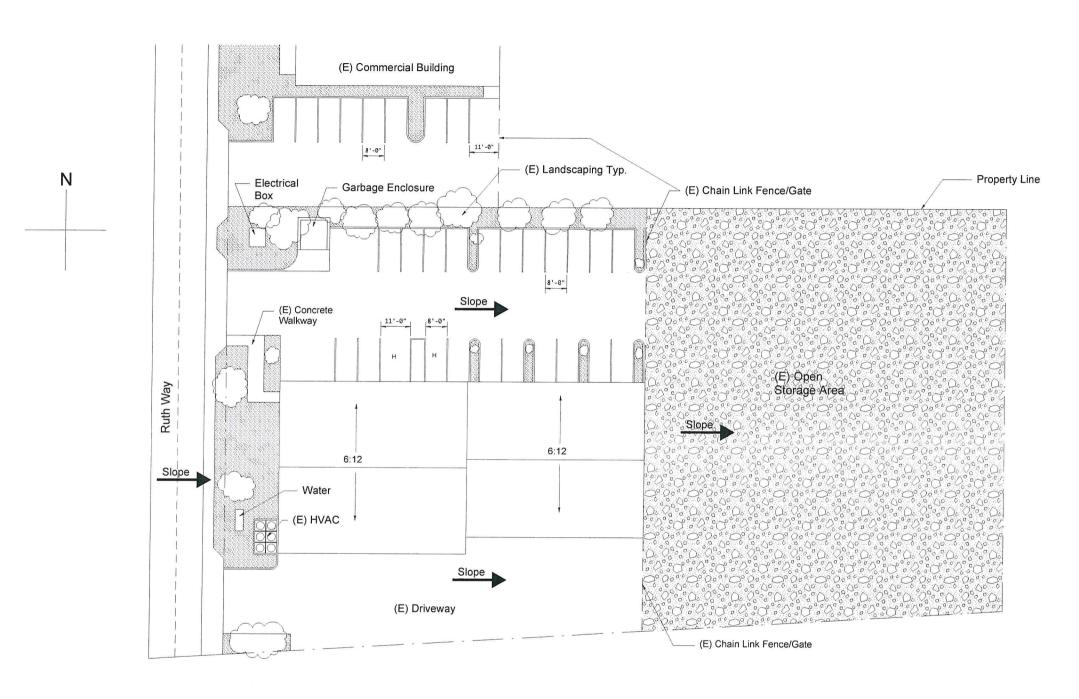

Exist Existing, No Change
Exposed Exposed to Existing Structure
GB 5/8" Type "x" Gypsum Wallboard
24" 448" Suspended Acoustical Tile, Cirrus Beveled
Tegular by Armstrong with 15/16 White Suspension
System, Prelude MX by Armstrong (ICBO # 5175) or
Approved Equal

Ceiling Fixture Legend & Notes




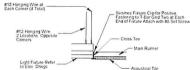

Light Fixture Support Notes

- 1. All wire shall have 3 tight turns minimum around itself.
- 2. Suspended ceiling shall comply with CBC tables 25-A and 16-O.

2 Typ. Light Fixture Support

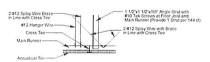

Ceiling Notes

- Hanger wire shall be located 4'-0" O.C. max. and 8" max. from face of wall.
- 2. Spay wire bracing shall be located 12'-0' O.C. max. each way and 4'-0" max. from face of wall.
- 3. All wire shall have 3 tight turns min. around itself.
- Provide 14ga. clips at all intersections and a hanger at each corner of light fixture.
- 5. Suspended ceiling shall comply with CBC tables 25-A and 16-O.


1 Typ. Seismic Brace

Wall Legend


Existing Wall to Remain

Wall Types

- A 3-5/8"x22ga MTL Studs @ 16" O C with 5/8" Type
 "X" GYP BD Each Side with 3" Sound Atten Blanket
 (1-Hour Rated) Full Height
- B With 5/8" Type 'X" GYP BD One Side on Existing Wall
- C 6"x22ga MTL Studs @ 16" O C with 5/8" Type X' GYP B D Each Side with 3" Sound Atten Blanket Full Height

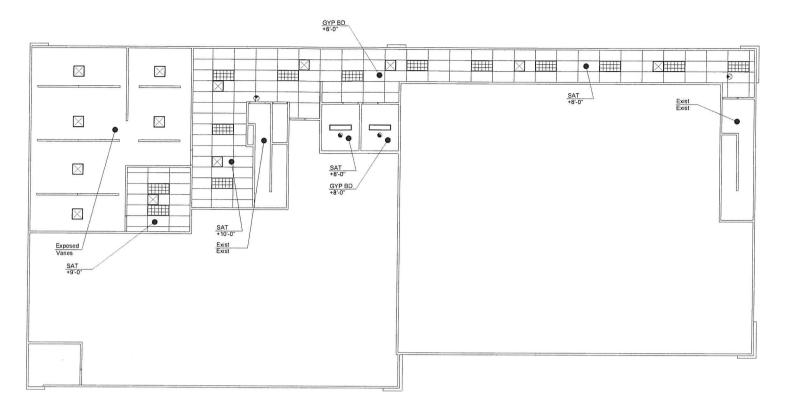

B Reflected Ceiling Plan

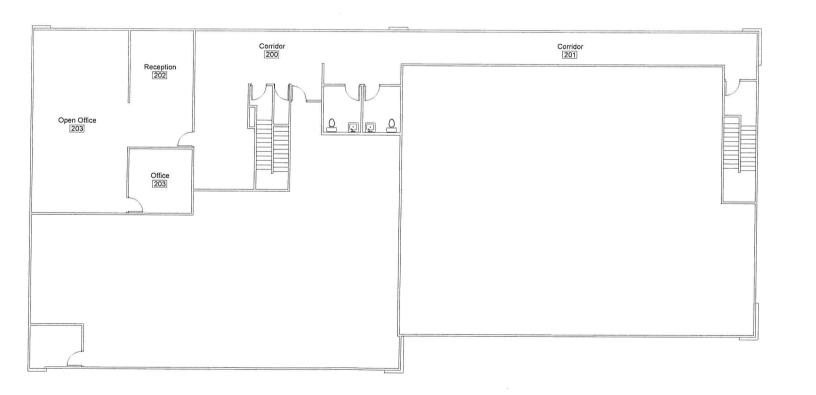

A Floor Plan
Scale 1/8"= 1' 0"

Revisions:

A MANAN
B
C
D

Legal Description: APN: 040-151-063 County Of San Luis Obispo

Commercial

Owner/Site Address: 3990 Ruth Way Suite D Paso Robles, CA 93446

Crizer Design Company, Inc. P.O. Box 6952 Los Osos, CA 93412 Ph. (805)528-4812 Fax 528-2325

Date:
6/26/18
Scale: 1/8"
Drawn By:
Sht.

REFERRAL -- Page 42 of 50




Legal Description: APN: 040-151-063 County Of San Luis Obispo

Commercial

Owner/Site Address: 3990 Ruth Way Suite D Paso Robles, CA 93446


Crizer Design Company, Inc. P.O. Box 6952 Los Osos, CA 93412 Ph. (805)528-4812 Fax 528-2325



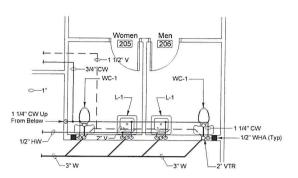

Plumbing Enlarged Floor Plan	
Scale 1/4"= 1' 0"	

						Plu	mbing	Fixtur	e S	ch	ed	ule						
Mark	Description		Min.	Bran	ch Siz	e (")	Make and Model											
IVIAIK			W	V	CW	HW	iviake an	ia ivioaei		Fittings						Remarks		
L-1	L-1 ADA Lavatory Wall Mount		2	1-1/2	1/2	10	Kohler "Kingston" #K2005, 21"x18" Vitreous China			Symmons Faucet #S-20-2-G-FR-IPS w/ Grid Strainer, Stops, Supplies, and C.P. Brass "P" Trap J.R. Smith Wall Support #0722					See Architectural Drawing for ADA Requirements			
WC-1	NC-1 ADA Water Closet Floor Mounted Elongated, 1.6 GPF			2	1-1/4		Kohler "Highcrest" #K-4302, 27-5/8" x 14 1/2" x 16 1/2" RIM, Vitreous China			Sloan Royal Flush Valve #111, and Olsonite Seat #10CC					See Architectural Drawing for ADA Requirements, Flush Valve Actuate to Wide Side of Space			
						V	Vater H	eater	Sch	nec	dul	е						
Mark	Make	Model		age	Dimer	neione	Full Weight	Inlet/ Outlet	Р	owe	r	KIM	мвтин	Branch	Flue	Remarks		
IVIAIN	Make	Wake	Wake	Woder	(Gall		Dilliel	1510113	(Pounds)		Volts	РН	CY	KVV	MBIOH		Size (Inches)	Remarks
WH-1	A.O. Smith	DEL-10	1)	0	18-1/4"x18"ø		135	3/4"	120	1	60	1.5	_	-	_	Provide with Smitty Dra Pan Attach to Wall w Approved Seismec Restraint Spacemaker #TSE-25		

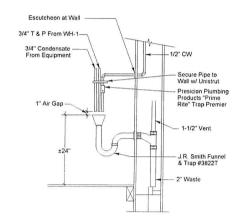



Open Office [203]	3/4" Secondary Drain 200 F-2 ms 80MBTUH Funnel 1/2 ms 1/2	Corridor [201] See Enlarged Plan This Sheet

Plumbing Second Floor Plan
Scale 1/8"= 1' 0"

REFERRAL -- Page 43 of 50



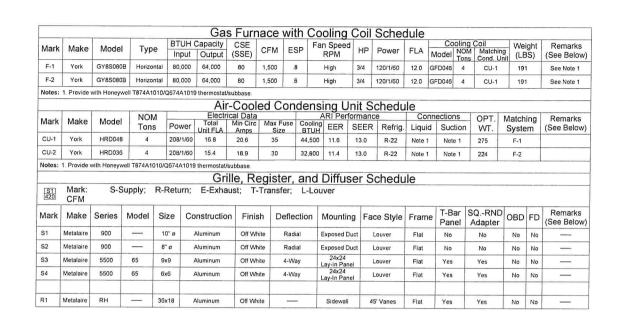

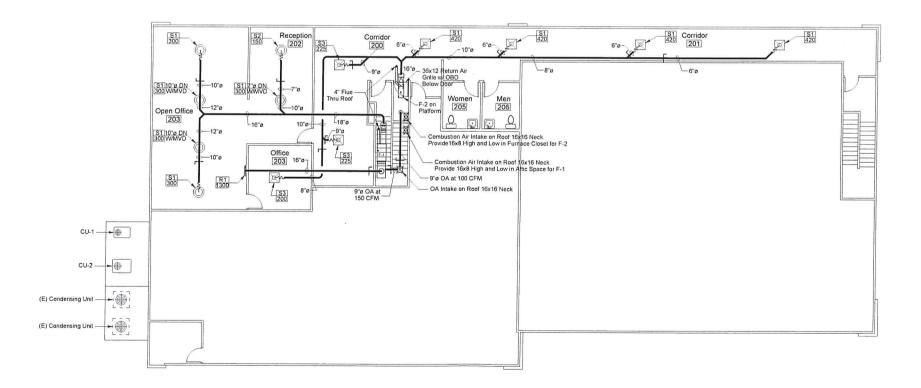

B Mechanical Second Floor Plan
Scale 1/8"= 1' 0"

Exist Exposed GB SAT

Existing, No Change
Exposed to Existing Structure
5/16" Type: "Cypsum Wallboard
24"+28" Suspended Acoustical Tile, Cirrus Beveled
Tegular by Armstrong with 15/16 White Suspension
System, Predude MX by Armstrong (ICBO # 5175) or
Approved Equal

Ceiling Fixture Legend & Notes

2"x2" Fluorescent Light Fixture X Supply Air Diffuser Cove Light w/ Strip Flaurescent Return Air Grille Track Light Fixture → Wall Mounted Light Fisture (S) Speaker Wall Mounted Uplicant County Committee on August South


 Horizontal Dimensions. All dimensions shown are from face of \$10.5 face of concrete or face of \$1.0 U unless otherwise noted office of \$1.0 U unless otherwise noted office. 2) Vertical Dimensions Dimensions 4) See interior plans for decorative shown are from face of ceiling to finished floor

#12 Hanging Wire at ____ Each Corner (4 Total)

Light Fixture Support Notes 1. All wire shall have 3 tight turns minimum around itself.

2. Suspended ceiling shall comply with CBC tables 25-A and 16-O.

2 Typ. Light Fixture Support

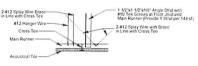

Ceiling Notes

Hanger wire shall be located 4'-0" O.C. max. and 8" max. from face of wall.

2. Spay wire bracing shall be located 12'-0" O.C. max. each way and 4'-0" max. from face of wall.

3. All wire shall have 3 tight turns min. around itself.

4. Provide 14ga, clips at all intersections and a hanger at each corner of light fixture.

5. Suspended ceiling shall comply with CBC tables 25-A and 16-O.

1 Typ. Seismic Brace

Wall Legend

Wall Types A 3-5/8"x22pa MTL Studs @ 16" O C with 5/8" Type
'K' GYP BD Each Side with 3" Sound Atten Blanket
(1-Hour Rated) Full Height

B With 5/8" Type 'X" GYP BD One Side on Existing Wall

Stair Notes


All stairs shall have 1 1/2" O.D. max, handrails each side of stair mounted at 34" above stair nosings.

3. Handrails shall be smooth with the ends returned or shall have rounded terminations or bends.


4. Handrails shall not project more than 3° from the wall and have a space between the handrail and the wall of not less than 1 1/2°.

All edges of treads shall be free from sharp objects and have smooth, rounded edges.

Nosings shall not project more than 1 1/2" past the face of the riser.

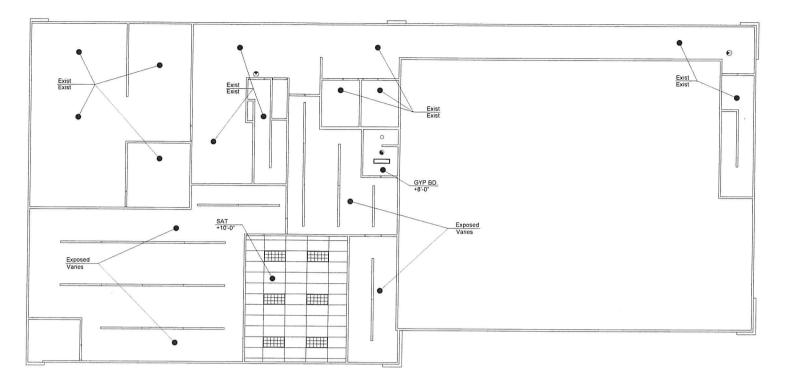

B Reflected Ceiling Plan
Scale 1/8"= 1' 0"

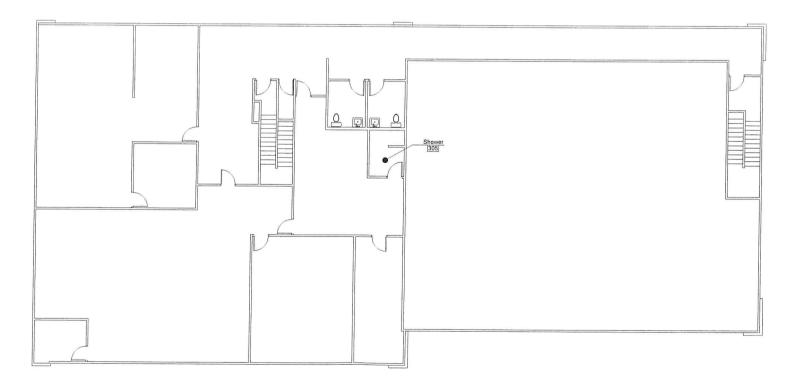

A Floor Plan
Scale 1/8"= 1' 0"

A XX/XX/XX /Ď.

Legal Description: APN: 040-151-063 County Of San Luis Obispo

Commercial


Owner/Site Address: 3990 Ruth Way Suite D Paso Robles, CA 93446

Crizer Design Company, Inc. O. Box 6952 Los Osos, CA 93412 (805)528-4812 Fax 528-2325 P.O. Ph. (

6/26/18 Scale: 1/8" Drawn By:
RC
Sht. ?

REFERRAL -- Page 45 of 50



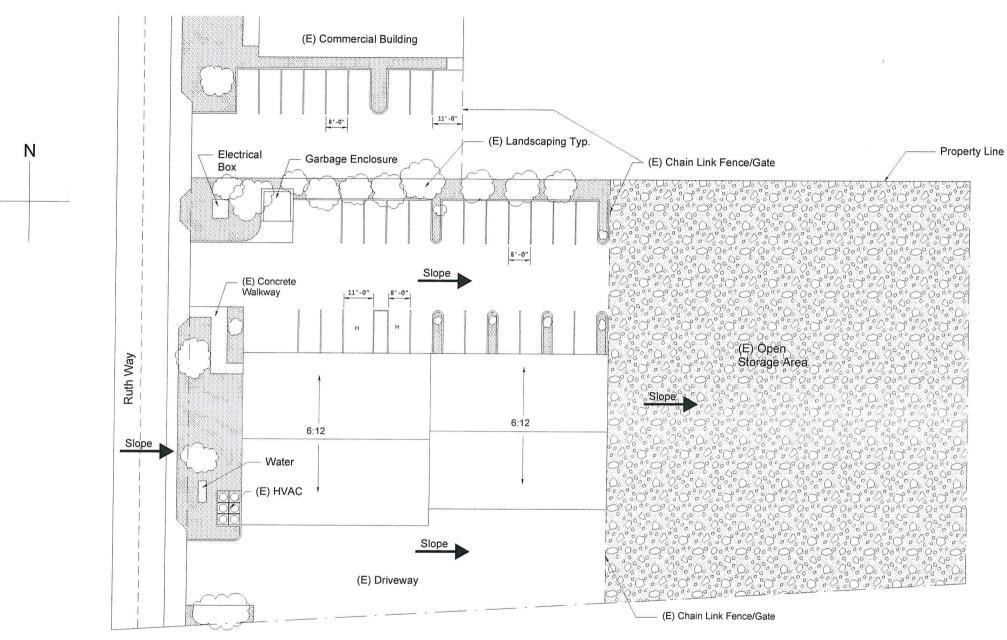

Existing, No Change
Exposed to Existing Structure
5/6" Type "K Gypsum Wallboard
24" x48" "Suspended Acoustical Tile, Cirrus Beveled
Tegular by Amristrong with 15/16 White Suspension
System, Prelude MX by Armstrong (ICBO # 5175) or
Approved Equa.

Ceiling Fixture Legend & Notes

2"x2" Fluorescent Light Fixture | X | Supply Air Diffuser Cove Light w/ Strip Flourescent Return Ar Grille ______ Track Light Fixture O Recessed Light Fixture SC Security Camera SM Seconty Converts Monitor (Co. 1 1 1 2 2 2 Decorative Indirect Light Fixture

Television, Mount @ 5' 6" A P P


 Horizontal Dimensions: All dimensions:
 Shown are from face of studs, face of concete:
 face of C M U unless otherwise noted of children walls/breams unless of tace of C M U unless otherwise noted. Vertical Dimensions. Dimensions shown are from face of ceiling to wall mounted light fixture locations resided flore.

#12 Hanging Wire at ____ Each Corner (4 Total)

Light Fixture Support Notes

- 2. Suspended ceiling shall comply with CBC tables 25-A and 16-O.

2 Typ. Light Fixture Support

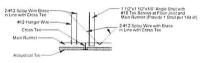

Ceiling Notes

- Hanger wire shall be located 4'-0" O.C. max, and 8" max, from face of wall,
- 2. Spay wire bracing shall be located 12'-0" O.C. max. each way and 4'-0" max. from face of wall.
- 3. All wire shall have 3 tight turns min. around itself,
- 4. Provide 14ga, clips at all intersections and a hanger at each corner of light fixture.
- 5. Suspended ceiling shall comply with CBC tables 25-A and 16-O.


1 Typ. Seismic Brace

Wall Legend


Existing Wall to Remain

Wall Types

- A 3-5/8"x22ga MTL Studs @ 16" O.C with 5/8" Type
 "X" GYP BD Each Side with 3" Sound Atten Blanket
 (1-Hour Rated) Full Height
- B With 5/8" Type 'X" GYP BD One Side on Existing Wall
- C 6"x22ga MTL Studs @ 16" O C with 5/8" Type "X" GYP B D Each Side with 3" Sound Atten Blanket Full Height

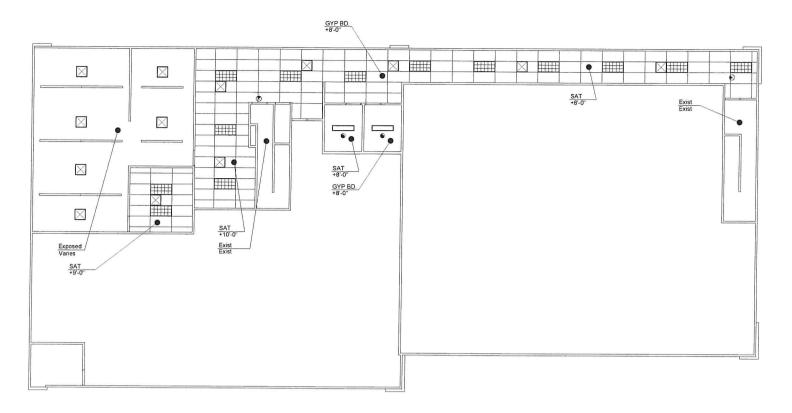

B Reflected Ceiling Plan

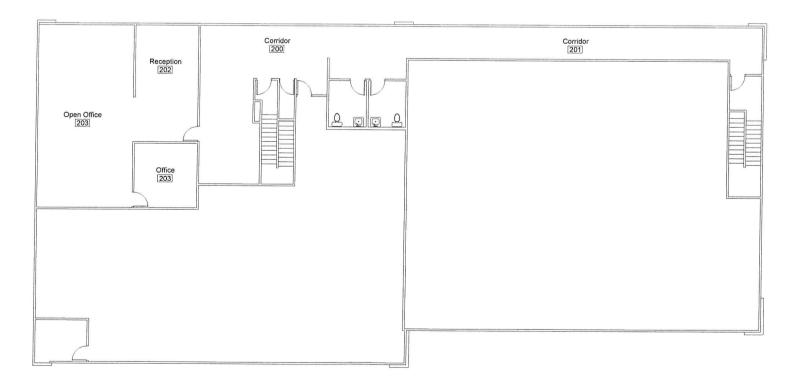

A Floor Plan
Scale 1/8"= 1' 0"

Revisions: A XX/XX/XX /D

Legal Description: APN: 040-151-063 County Of San Luis Obispo

Commercial

Owner/Site Address: 3990 Ruth Way Suite D Paso Robles, CA 93446

Crizer Design Company, Inc. O. Box 6952 Los Osos, CA 93412 I. (805)528-4812 Fax 528-2325 P.O. Ph. (8

Date: 6/26/18 Scale: 1/8" Drawn By: Sht. ?

REFERRAL -- Page 47 of 50




Legal Description: APN: 040-151-063 County Of San Luis Obispo

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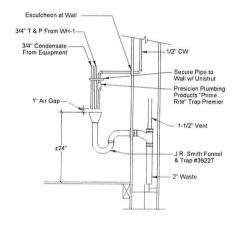
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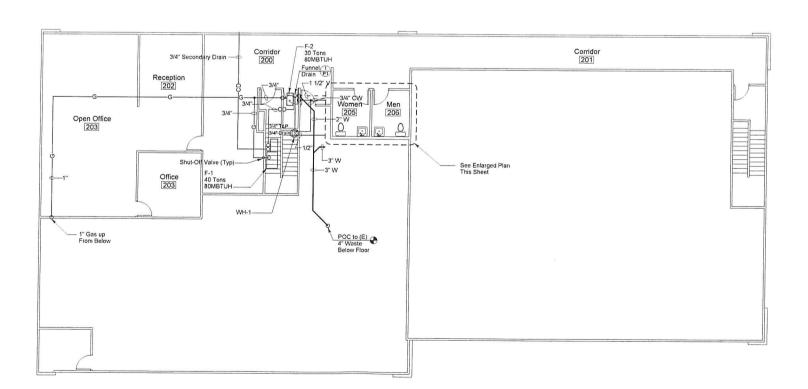




Plumbing Enlarged Floor Plan	
Scale 1/4"= 1' 0"	


	,						mbing	FIXTU	e S	cn	ea	ule						
Mark	Description		Min.	Bran	ch Siz	e (")	Make and Model											
IVIAIK	Desci	Description		V	CW	HW	Make ar	id Model		Fittings						Remarks		
L-1	L-1 ADA Lavatory Wall Mount			1-1/2	1/2	1/2							See Architectural Drawing for ADA Requirements					
WC-1	ADA Water Closet Floor Mounted Elongated, 1.6 GPF			2	1-1/4	_	Kohler "Higherest" #K-4302. 27-5/6" x 14 1/2" x 16 1/2" RIM, Vitreous China					Requirement	iee Architectural Drawing for ADA lequirements. Flush Valve Actuator Wide Side of Space					
						V	Vater H	eater	Sch	nec	lul	е						
Mark	Make	Model	Stor		Dimer	neione	Full Weight	Inlet/ Outlet	Р	owe	Г	KIM	мвтин	Branch Size	Flue Size	Remarks		
Mark	Make	Wiodei	(Gall		Dillici	1310113	(Pounds)	(Inches)	Volts	РН	CY	KVV			(Inches)	Remarks		
WH-1	A.O. Smith	DEL-10	10	0	18-1/4"x18"ø		135	3/4"	120	1	60	1.5	-	-	-	Provide with Smitty Drain Pan Attach to Wall W Approved Seismec Restraint Spacemaker #TSE-25		

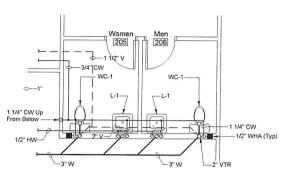




Plumbing Second Floor Plan
Scale 1/8"= 1'0"



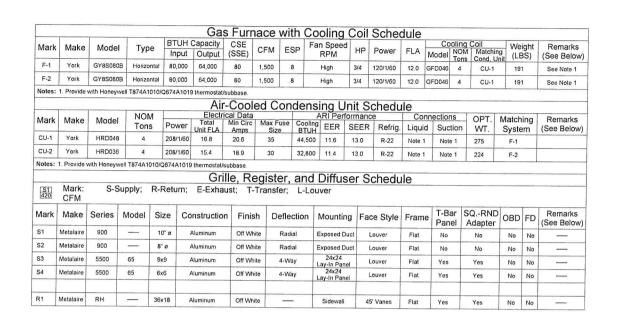

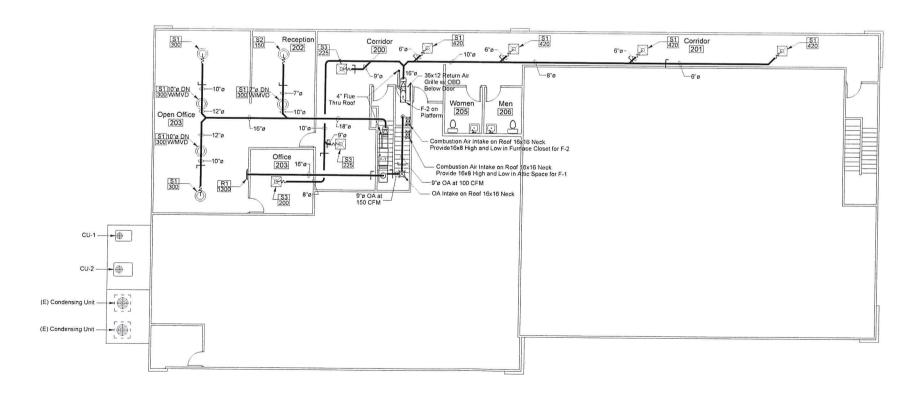


B Mechanical Second Floor Plan Scale 1/8"= 1'0"

Existing, No Change
Exposed to Existing Structure
5/8" Type 'x' Gypsum Wallboard
24" x48" Supended Acoustical Tile, Cirrus Beveled
Tegular by Armstong with 15/16 White Suspension
System, Prelude MX by Armstrong (ICBO # 5175) or
Approved Equal



 Horizontal Dimensions. All dimensions shown are from face of study, face of concrete, or face of C M U unless otherwise noted.


3) Light fixtures, diffusers, grilles to be centered between walls/beams unless otherwise noted. Vertical Dimensions Dimensions 4) See intenor plans for decorative shown are from face of ceiling to wall mounted light facture locations finished floor.

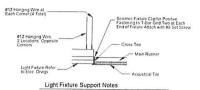

1. All wire shall have 3 tight turns minimum around itself.

2. Suspended ceiling shall comply with CBC tables 25-A and 16-O.

2 Typ. Light Fixture Support

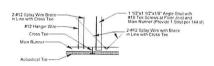

Ceiling Notes

Hanger wire shall be located 4'-0" O.C. max. and 8' max. from face of wall.

2. Spay wire bracing shall be located 12'-0' O.C. max. each way and 4'-0' max. from face of wall.

3. All wire shall have 3 tight turns min. around itself.

Provide 14ga, clips at all intersections and a hanger at each corner of light fixture.

5. Suspended ceiling shall comply with CBC tables 25-A and 16-O.

Typ. Seismic Brace

Wall Legend

Existing Wall to Remain

Wall Types

A 3-5/6"x22ga MTL Studs @ 16" O C with 5/8" Type
"X" GYP BD Each Side with 3" Sound Atten Blanket
(1-Hour Rated) Full Height

B With 5/8" Type "X" GYP BD One Side on Existing Wall

Stair Notes

All stairs shall have 1 1/2" O.D. max. handrails each side of stair mounted at 34" above stair nosings.

2. Handrails shall extend 12" beyond the top riser and 24" beyond the bottom riser.


3. Handrails shall be smooth with the ends returned or shall have rounded terminations or bends.

Handrails shall not project more than 3° from the wall and have a space between the handrail and the wall of not less than 1 1/2°.


All edges of treads shall be free from sharp objects and have smooth, rounded edges.

6. Nosings shall not project more than 1 1/2" past the face of the riser.

7. Provide a 2° wide slip resistant color contrasting warning strip parallel to and not more than 1° from the step nosing, strip to be replaced on the upper tread and lower tread of each stair run.

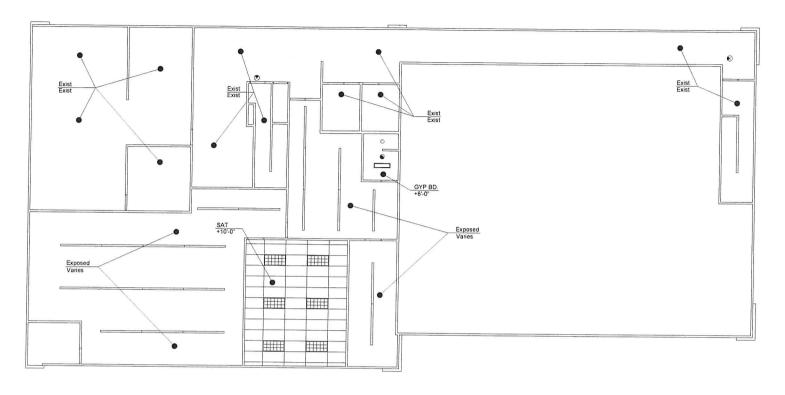

B Reflected Ceiling Plan
Scale 1/8"= 1' 0"

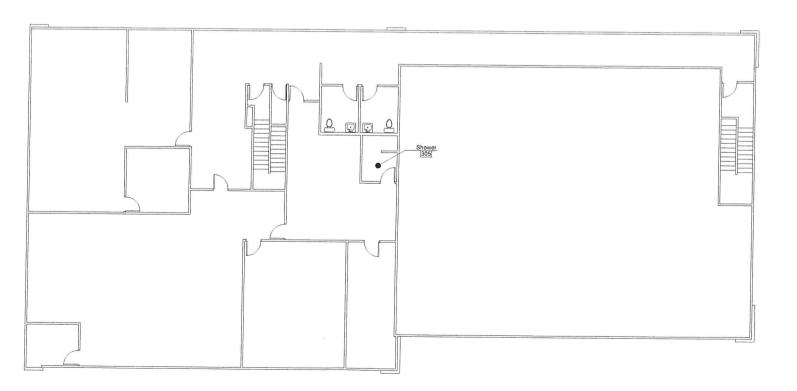

A Floor Plan
Scale 1/8"= 1' 0"

A XX/XX/XX /D

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