
Appendix A

Project Description Information

Table of Contents	<u>Page</u>
Grading Plans -Proposed Project	B-1
Grading Plans - Conservative Alternative	B-24
Phase 1 Site Assessment Summary	B-43
San Luis Obispo Department of Planning and Building Applications Forms	B-49
Groundwater monitoring Wells Map	B-70
California State Lands Commission Outfall Lease	B-71

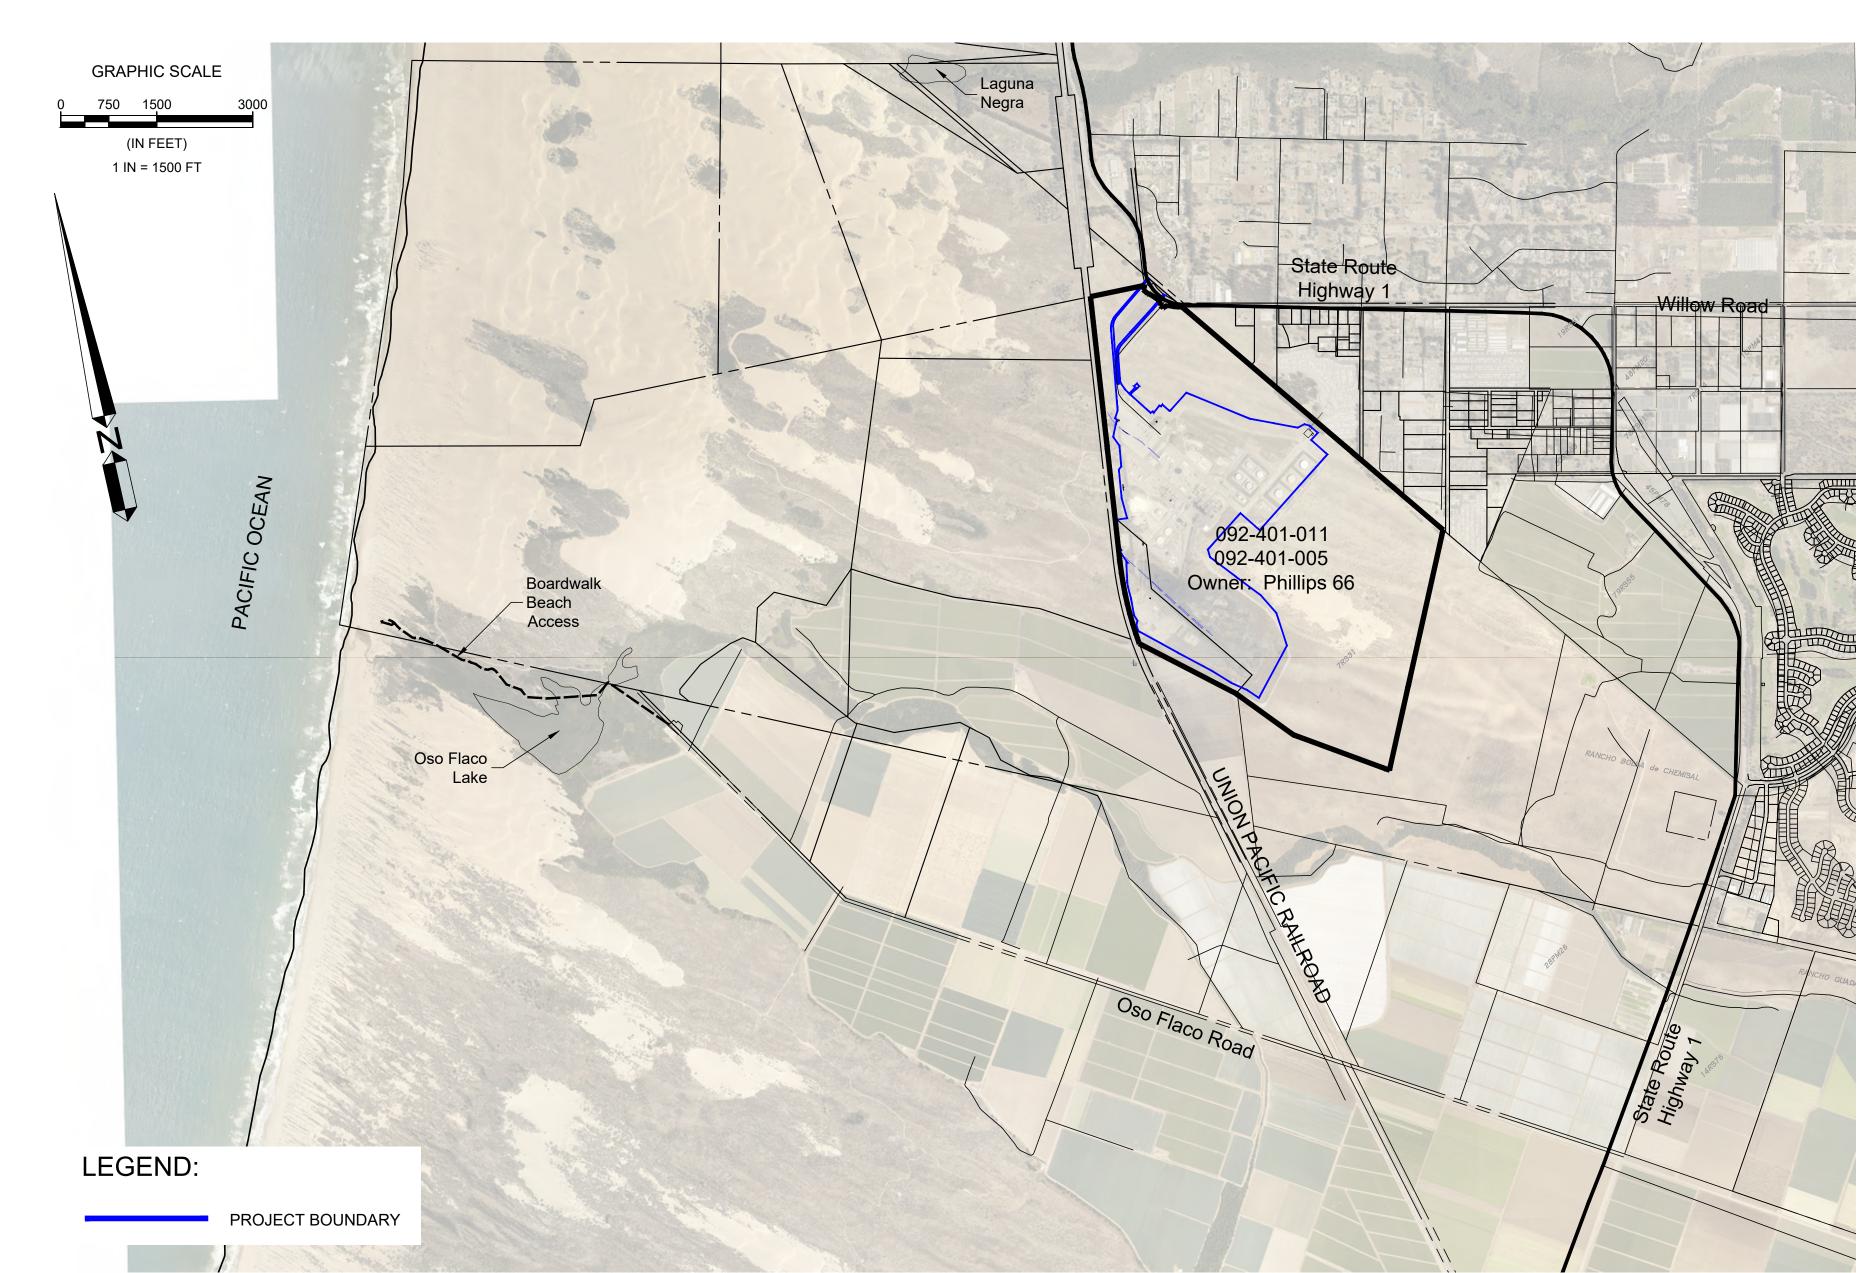

	Grading Quantities Table (Project Description, sect.)	Area 1 - Upper Tank	Area 2 - Lower Tank	Area 3 - Process	Area 4 - Coker	Area 5 - Sulfur	Area 6 - Coke Storage	Area 7 - Wastewater	Site Total	Soil Total
4	Voids to be Filled CY					12				
a)	Crushed Concrete/Asphalt/Debris								5,620	
_	Non-Impacted Mixed Debris (Export)			v	ARIOUS LOCATION	S		- 1	1,470	
	Impacted Concrete/Asphalt/Sewer (Export)				7.11.11000				4,150	
b)	Impacted Soil Cut (Export)	7,525	13,650	32,102	52,404	16,596	77,691	532	200,500	200,500
c)	Native Soil Fill (Recontouring)	7,525	13,650	32,102	52,404	16,596	77,691	532	200,500	200,500
	Native Soil Fill (Replace Excavated Debris and Subgrade)			٧	ARIOUS LOCATION	s			2,420	2,420
	Total Earthwork Voids/Fill (a + b + c)								409,040	403,420
3	Soil Cut Volume CY									
a)	Impacted Soil Cut (Export)	7,525	13,650	32,102	52,404	16,596	77,691	532	200,500	200,500
	Non-impacted Mixed Debris (Export)					0			1,470	
	Impacted Concrete Cut (Export)			V	ARIOUS LOCATION	5			4,150	
b)	Native Soil Cut (Recontouring+Debris Backfil)						202,920		202,920	202,920
	Total Earthwork Cut (a + b)								409,040	403,420
3	Cut & Fill Balance CY									
a)	Total Cut (Remediation/Native)	7,525	13,650	32,102	52,404	16,596	280,611	532	403,420	403,420
	Total Cut (Debris/Concrete)			V	ARIOUS LOCATION	S			5,620	
b)	Native Soil Fill (Recontouring)	7,525	13,650	32,102	52,404	16,596	77,691	532	200,500	200,500
	Native Soil Fill (Replace Excavated Debris and Subgrade)			V	ARIOUS LOCATION	S			2,420	2,420
	Other Fill								3,200	
	Concrete/Base/Gravel/Slurry (Import)			V	ARIOUS LOCATION	S			1,000	
	Non-Impacted Above Grade Crushed Concrete (Recontouring)							- 1	2,200	
	Balance (a - b - c)								202,920	200,500
	Total Earthwork Quantity CY							- 10		
a)	Onsite Cut + Fill Native Soils			V	ARIOUS LOCATION	S			615,160	606,340
	Total Earthwork								615,160	606,340

Preliminary Post Redmediation Grading, Drainage and Erosion Control Plan -- Proposed Project

OWNER

PHILLIPS 66 SANTA MARIA FACILITY 2555 WILLOW ROAD

ARROYO GRANDE, CALIFORNIA 93420

CONTACT INFORMATION

SAN LUIS OBISPO COUNTY DEPARTMENT OF PLANNING AND BUILDING SUSAN STRACHAN/CINDY CHAMBERS

OWNER'S REPRESENTATIVE **TOMAS ZAMBRANO** (510) 245-5879

(805) 544-4011

REGISTERED CIVIL ENGINEER TOM ZEHNDER, PE C72702, WALLACE GROUP

SITE INFORMATION

APN: 092-401-011, 092-401-005 (LOCATION OF PROJECT WORK)

PROJECT LOT SIZE: 603 ACRES CONTIGUOUS LOTS SIZE: 1,656 ACRES - SEE SHEET EIR-GP-EXT-002

ZONING: INDUSTRIAL

ACCESS TO THE SITE IS VIA HIGHWAY 1 AND THROUGH GATE No. 1 ON THE PROPERTY. ALL SITE ACCESS SHALL BE COORDINATED VIA TOMAS ZAMBRANO OR HIS DESIGNEE. THE FOLLOWING INFORMATION MUST BE PROVIDED PRIOR TO ENTRY:

- 1. PHOTO ID
- 2. NAME, COMPANY REPRESENTING CONTACT PERSON AT REFINERY
- 4. IF REQUIRED, APPOINTMENT FOR SITE SAFETY TRAINING

PROJECT DESCRIPTION

- DEMOLISH THE SANTA MARIA REFINERY, INCLUDING ABOVEGROUND DEMOLITION AND SOIL REMEDIATION. RETAIN INFRASTRUCTURE TO BE KEPT IN PLACE FOR POTENTIAL USE BY SUBSEQUENT SITE OCCUPANTS. RETAIN NON-IMPACTED BELOWGROUND FACILITIES AND HARDSCAPE.
- 2. ACHIEVE SOIL REMEDIATION AT THE PROJECT SITE THAT MEETS APPLICABLE RISK-BASED INDUSTRIAL STANDARDS IN A COST-EFFECTIVE MANNER.

SCOPE OF WORK

THE SCOPE OF THIS PRELIMINARY GRADING PLAN IS INTENDED FOR THE PREPARATION OF THE SITE. TWO GRADING SCENARIOS ARE PRESENTED. THE CONSERVATIVE ("CONS") CASE IS INTENDED FOR PREPARATION OF THE ENVIRONMENTAL IMPACT REPORT. THE PROPOSED ("PROP") CASE IS INTENDED FOR THE EXPECTED LEVEL OF DISTURBANCE PENDING SITE CHARACTERIZATION AND DETAILED PLANNING AND OUTLINED IN PLAN SET. CONSTRUCTION DOCUMENTS WILL BE UNDER A

REFERENCE DOCUMENTS

1. ALTA PREPARED BY STANTEC DATED NOVEMBER 15, 2021

- 2. PROJECT DESCRIPTION PREPARED BY ERM DATED OCTOBER 2023
- 3. CONTOURS DERIVED FROM EXISTING GRADE ELEVATION DATA BASED ON THE PUBLICLY AVAILABLE CA AZ FEMA R9 2017 D18 LIDAR SURVEY PERFORMED FOR THE UNITED STATES GELOGICAL SURVEY'S NATIONAL GEOSPATIAL TECHNICAL OPERATIONS CENTER (USGS-NGTOC), TASK ORDER #140G0218F0027, ACCORDING TO THE PROJECT REPORT PREPARED BY WOOLPERT CIRCA 2017. THIS ELEVATION DATA IS NOT TO BE USED FOR DESIGN PURPOSES.
- 4. EXTENT OF UNMAPPED ESHA PROVIDED BY COUNTY OF SAN LUIS OBISPO DATED DECEMBER 22, 2022

GENERAL NOTES:

- 1. APPROXIMATE REMEDIATED SOIL QUANTITY PROVIDED BY ERM. SPECIFIC LOCATION OF REMEDIATION WORK TO BE DETERMINED. REMEDIATED AREAS WILL EITHER BE BACKFILLED OR LEFT IN A STABLE EXCAVATED CONDITION WITH APPROPRIATE EROSION CONTROL MEASURES AND MAY FUNCTION TO RETAIN STORMWATER AS APPROPRIATE. IF BACKFILLED, BACKFILL MATERIAL WILL BE SOURCED ON SITE AND MINIMALLY IMPORTED. IN THE PROPOSED CASE, FACILITIES TO REMAIN INCLUDE FORMERLY OPERATIONAL SUBSURFACE LINES THAT HAVE BEEN CLEANED AND PURGED; NON-IMPACTED SUBSURFACE STRUCTURES (I.E., STRUCTURES THAT DO NOT REQUIRE REMEDIATION) INCLUDING FOUNDATIONS; AND HARDSCAPES.
- 2. ALL HARDSCAPE (CONCRETE, ASPHALT, GRAVEL BASE SURFACES) TO REMAIN UNLESS NEEDED TO BE REMOVED FOR REMEDIATION PURPOSES. HARDSCAPE THAT OVERLIES AREAS TO BE REMEDIATED WILL BE REMOVED AND REPLACED WITH CRUSHED CONCRETE/ ASPHALT SOURCED FROM THE REMOVED HARDSCAPE OR IMPORTED MATERIAL, UNLESS IF LEFT IN AN EXCAVATED CONDITION. CRUSHED CONCRETE AND ASPHALT QUANTITIES BASED UPON ERM PROJECT DESCRIPTION DATA DATED OCTOBER 2023. SUBJECT TO THE LEVEL OF SITE GRADING, CONCRETE WALLS, FOUNDATIONS AND OTHER STRUCTURES WILL BE, AT A MINIMUM, REMOVED TO 6" ABOVE FINISHED GRADE. CRUSHED CONCRETE AND ASPHALT TO BE DISPOSED OF ON SITE.
- 3. EXISTING SITE TOPOGRAPHIC CONTOURS REFLECT THE PRESENCE OF EXISTING SULFUR AND COKE STOCK PILES THAT WILL BE REMOVED PRIOR TO START OF REMEDIATION. THESE STOCKPILE VOLUMES ARE NOT INCLUDED IN THE GRADING QUANTITIES.
- 4. SLOPE ANALYSIS ACREAGES ARE ONLY FOR THE AREA WITHIN THE REFINERY FENCE LINE.
- 5. NO IMPORT OF TOPSOIL FOR RE-VEGETATION IS REQUIRED.
- 6. SLOPES WILL BE STABILIZED PER THE EROSION CONTROL PLAN. VEGETATED AREAS THAT ARE EXCAVATED WITHIN ESHA AREAS WILL BE RE-VEGETATED.
- 7. ALL EXISTING ROADS MINIMUM WIDTH OF 20' AND OF ASPHALT CONSTRUCTION WITH THE EXCEPTION OF A PORTION OF THE PERIMETER ROAD WHICH IS OF GRAVEL CONSTRUCTION.
- 8. GRADING TABLE AREAS ARE BASED UPON REMEDIATION AREAS SHOWN ON THE GRADING PLAN. IN THE PROPOSED CASE, THERE ARE NO CUT SLOPES EXCEPT FOR SOURCING BACKFILL MATERIAL. REMEDIATION EXCAVATION AND ASSOCIATED EARTHWORK BACKFILL LOCATIONS COULD OCCUR AT ANY LOCATION. SUCH POTENTIAL LOCATIONS WILL BE DETERMINED DURING SITE CHARACTERIZATION.
- 9. HARDSCAPES (CONCRETE, ASPHALT, COMPACTED BASE/GRAVEL, OR ASPHALT EMULSION COATING) WHERE GROUND DISTURBANCE IS NOT REQUIRED FOR BELOW GROUND DEMOLITION OR REMEDIATION MAY REMAIN FOR POTENTIAL FUTURE DEVELOPMENT BY OTHERS.
- 10. TOTAL POTENTIAL AREA OF DISTURBANCE 177.26 AC.
- 11. THE FOLLOWING BUILDING PERMITS ARE ACTIVE ON THE SITE:
 - o PMTG2020-00056 MAJOR GRADING (14.520 CY) FOR SOILS REMEDIATION FOR PHILLIPS 66
- CMEP2022-00027 ANNUAL 2022 ELECTRICAL MAINTENANCE PERMIT.
- 12. PROTECT ALL MONITORING WELLS. MAINTAIN ACCESS TO ALL WELLS AND ADD OR REMOVE WELL CASING TO PROVIDE ACCESS TO WELLS AT EXISTING OR FINAL GRADE.

Sheet List Table					
Sheet Number	Sheet Title	Date	Rev#		
001A	Title Sheet	10/31/2023	5		
002A	Adjacent Properties	10/13/2023	4		
003A	Existing Site Plan	10/31/2023	3		
004A	Existing Ground Surfaces	10/13/2023	1		
005A	Existing Topography Plan (North)	10/13/2023	3		
006A	Existing Topography Plan (South)	10/13/2023	3		
007A	Existing Topo Slope Map (North)	10/13/2023	3		
008A	Existing Topo Slope Map (South)	10/13/2023	3		
009A	Existing Infrastructure to Remain	10/13/2023	4		
010A	Prelim. Grading and Earthwork Plan - Prop. Grading	10/13/2023	5		
011A	Cross Section Index - Prop. Grading	10/13/2023	4		
012A	Cross Sections - Prop. Grading	10/13/2023	3		
013A	Cross Sections - Prop. Grading	10/13/2023	3		
014A	Proposed Slope Map - Prop. Grading	10/13/2023	4		
015A	Drainage Plan - Prop. Grading	10/13/2023	4		
016A	Area of Site Distrubance Plan(North)	10/13/2023	4		
017A	Area of Site Distrubance Plan(South)	10/13/2023	4		
018A	Preliminary Erosion Control Plan - Prop. Grading	10/13/2023	4		
019A	Post Remediation Ground Surfaces	10/31/2023	2		
020A	Existing ALTA Sheet	9/20/2023	1		
021A	Existing ALTA Sheet	9/20/2023	1		
022A	Existing ALTA Sheet	9/20/2023	1		
023A	Existing ALTA Sheet	9/20/2023	1		

4 10–13–23 UPDATED PROJECT INFORMATION TKZ J 3 09–20–23 UPDATED PROJECT INFORMATION TKZ J 2 09–07–23 UPDATED PROJECT INFORMATION TKZ J 1 08–22–23 UPDATED FOR PERMITTING TKZ J					
4 10–13–23 UPDATED PROJECT INFORMATION TKZ J 3 09–20–23 UPDATED PROJECT INFORMATION TKZ J 2 09–07–23 UPDATED PROJECT INFORMATION TKZ J 1 08–22–23 UPDATED FOR PERMITTING TKZ J	REV	DATE	DESCRIPTION	CHECKED	APPROVE
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4 10–13–23 UPDATED PROJECT INFORMATION TKZ J 3 09–20–23 UPDATED PROJECT INFORMATION TKZ J	1	08-22-23	UPDATED FOR PERMITTING	TKZ	JOA
4 10-13-23 UPDATED PROJECT INFORMATION TKZ J	2	09-07-23	UPDATED PROJECT INFORMATION	TKZ	JOA
	3	09-20-23	UPDATED PROJECT INFORMATION	TKZ	JOA
5 10-31-23 OFDATED PROJECT INFORMATION TRZ J	4	10-13-23	UPDATED PROJECT INFORMATION	TKZ	JOA
5 10 31 23 LIDDATED DROJECT INFORMATION TV7	5	10-31-23	UPDATED PROJECT INFORMATION	TKZ	JOA

 ${\sf NOTICE} \quad {\sf this} \; {\sf drawing} \; {\sf has} \; {\sf not} \; {\sf been} \; {\sf published}. \quad {\sf it} \; {\sf is} \; {\sf the} \; {\sf sole} \; {\sf property} \; {\sf of} \; {\sf phillips} \; {\sf 66} \; {\sf co}. \quad {\sf it} \; {\sf is} \; {\sf lent} \; {\sf to} \; {\sf the}$ RECIPIENT FOR CONFIDENTIAL USE ONLY AND UPON THE CONDITIONS AND AGREEMENTS FOLLOWING: IN CONSIDERATION OF THE LOAN OF THIS DRAWING, THE RECIPIENT PROMISES AND AGREES TO RETURN IT UPON REQUEST, AND THAT IT SHALL NOT BE REPRODUCED, COPIED, LENT OR OTHERWISE DISPOSED OF, DIRECTLY OR INDIRECTLY WITHOUT PHILLIP 66 CO'S WRITTEN CONSENT, NOR BE USED IN ANY WAY DETRIMENTAL TO THE INTERESTS OF PHILLIPS 66 CO.

DESIGNED	RMS	DRAWN	RMS	CHECKED	TKZ	APPROVED	JOA
ВҮ		DATE					
ISSUED FOR (CONSTRUCTI	ON		CUSTOMER A	PPROVAL		



SANTA MARIA FACILITY

PHILLIPS 66 - SANTA MARIA REFINERY POST REMEDIATION PRELIMINARY GRADING PLAN

TITLE SHEET









AS SHOWN

EIR-GP-EXT-001A PROPOSED PROJECT

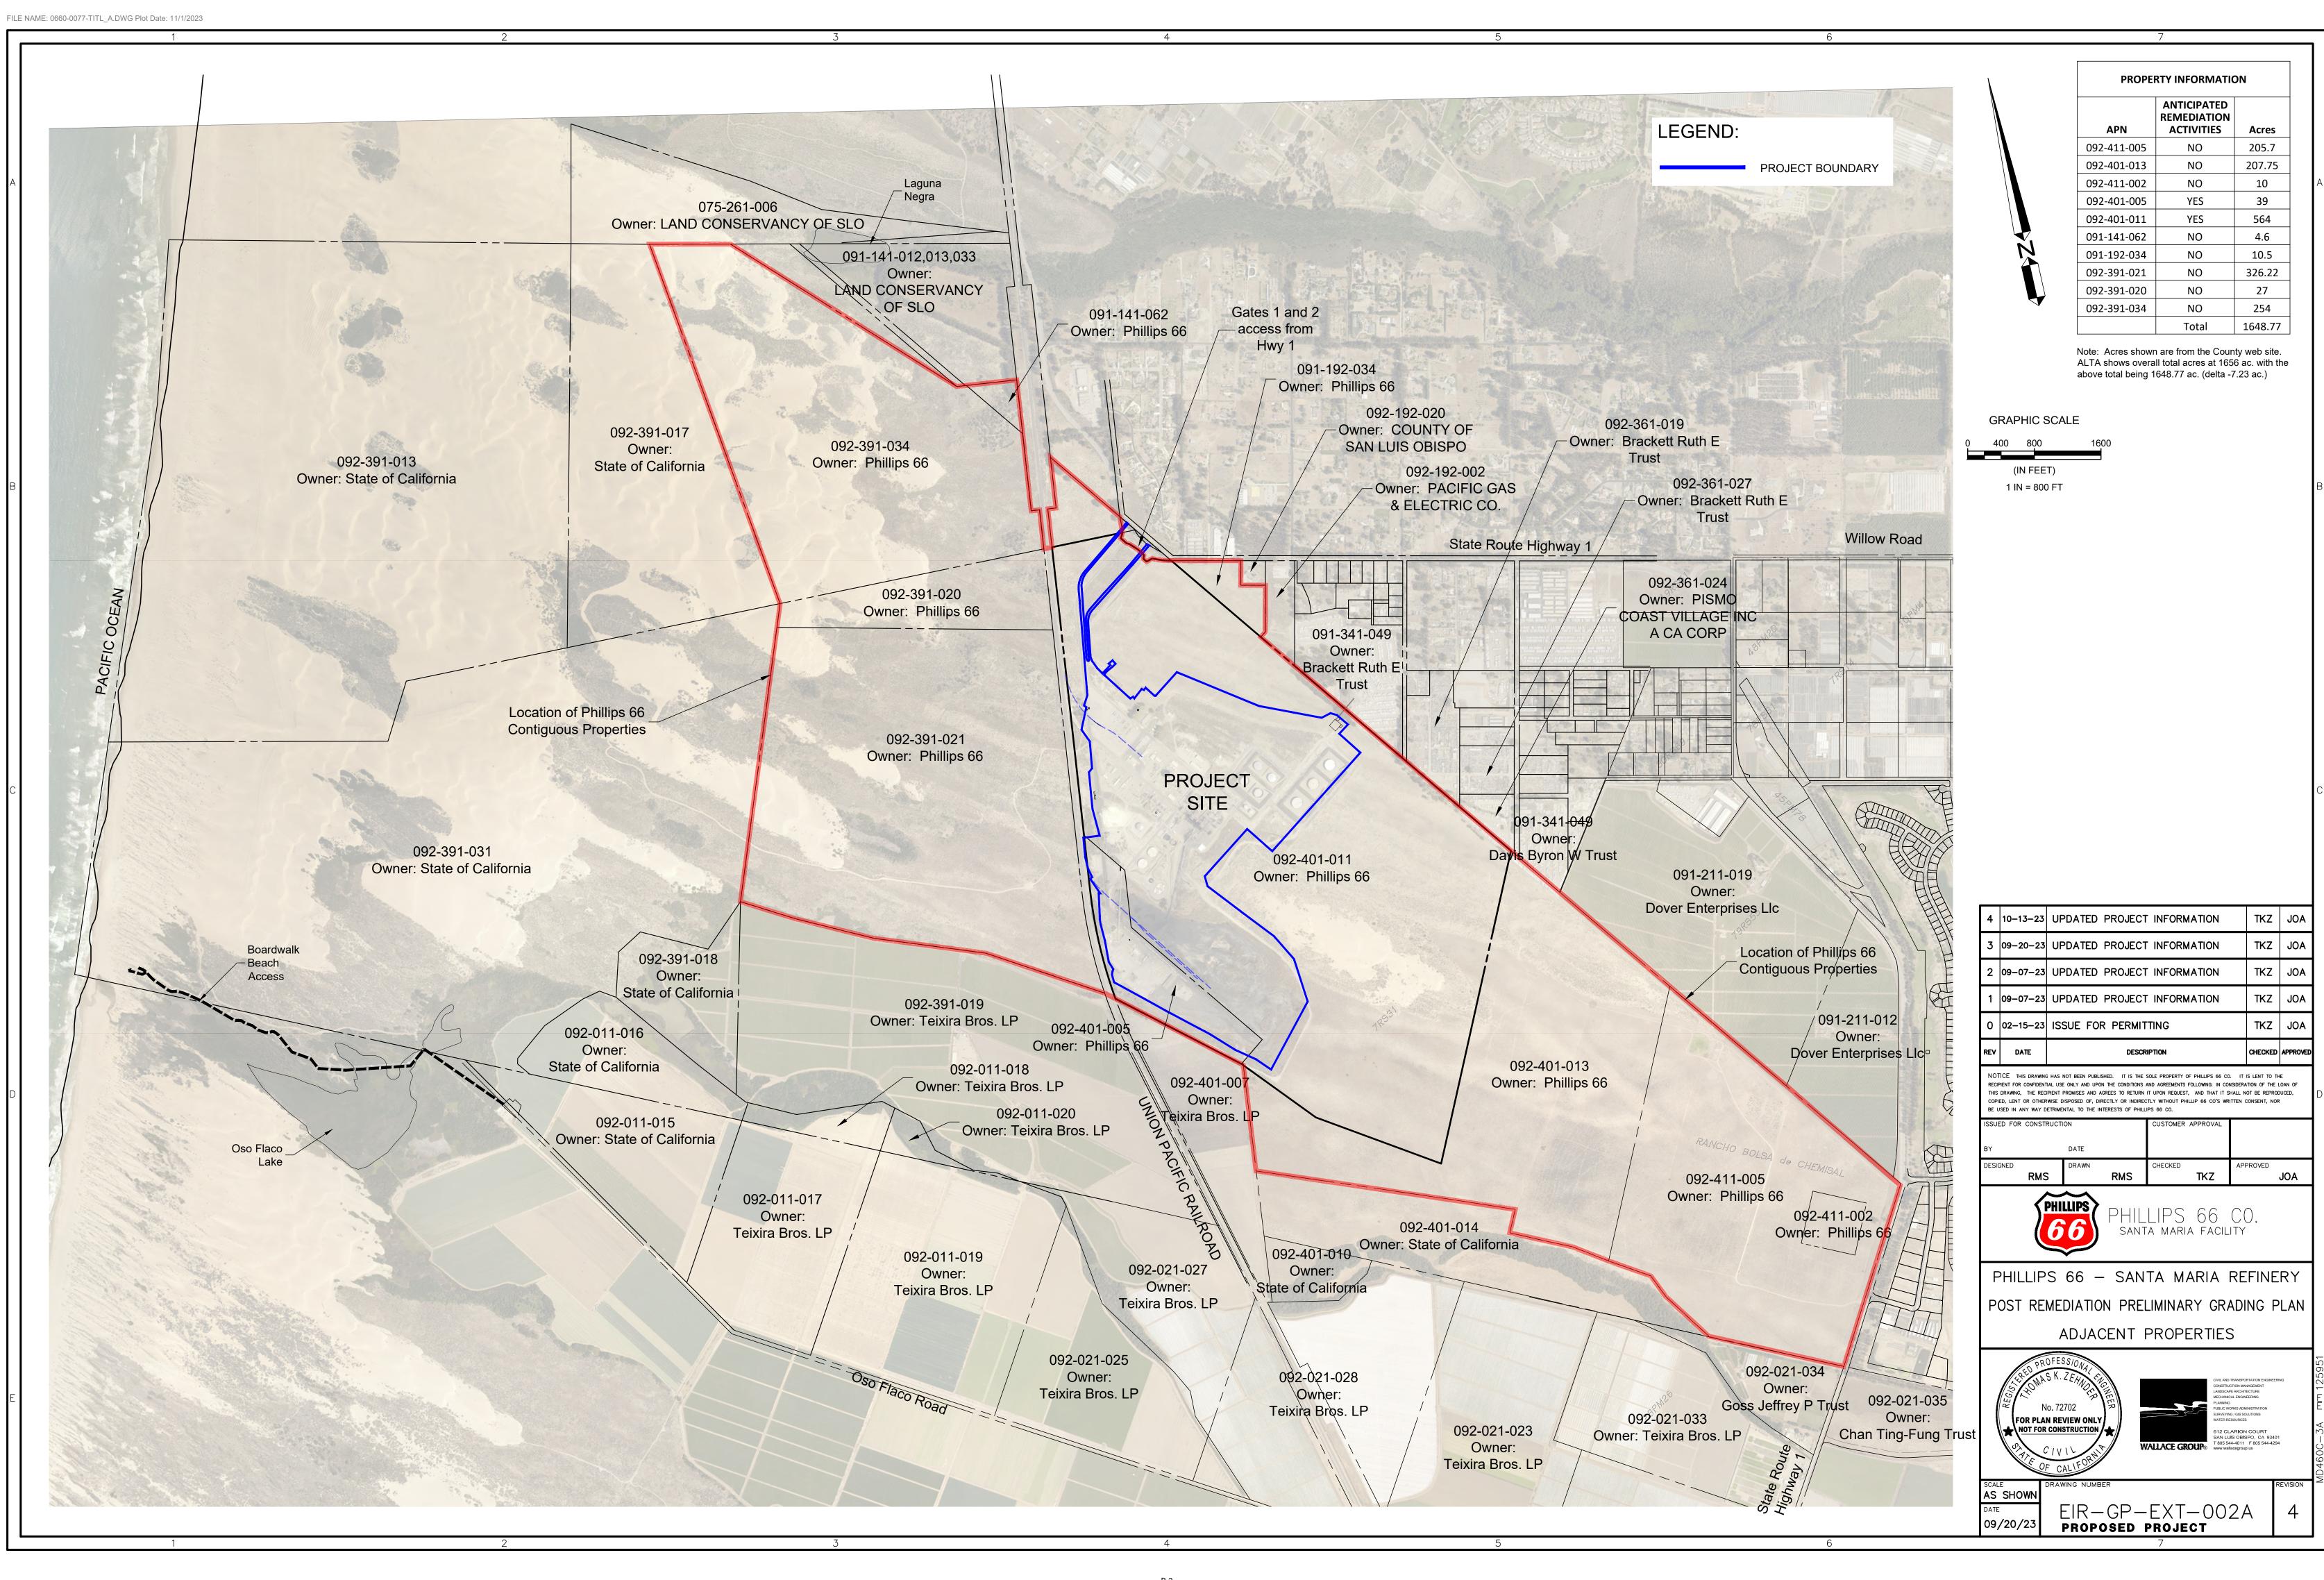

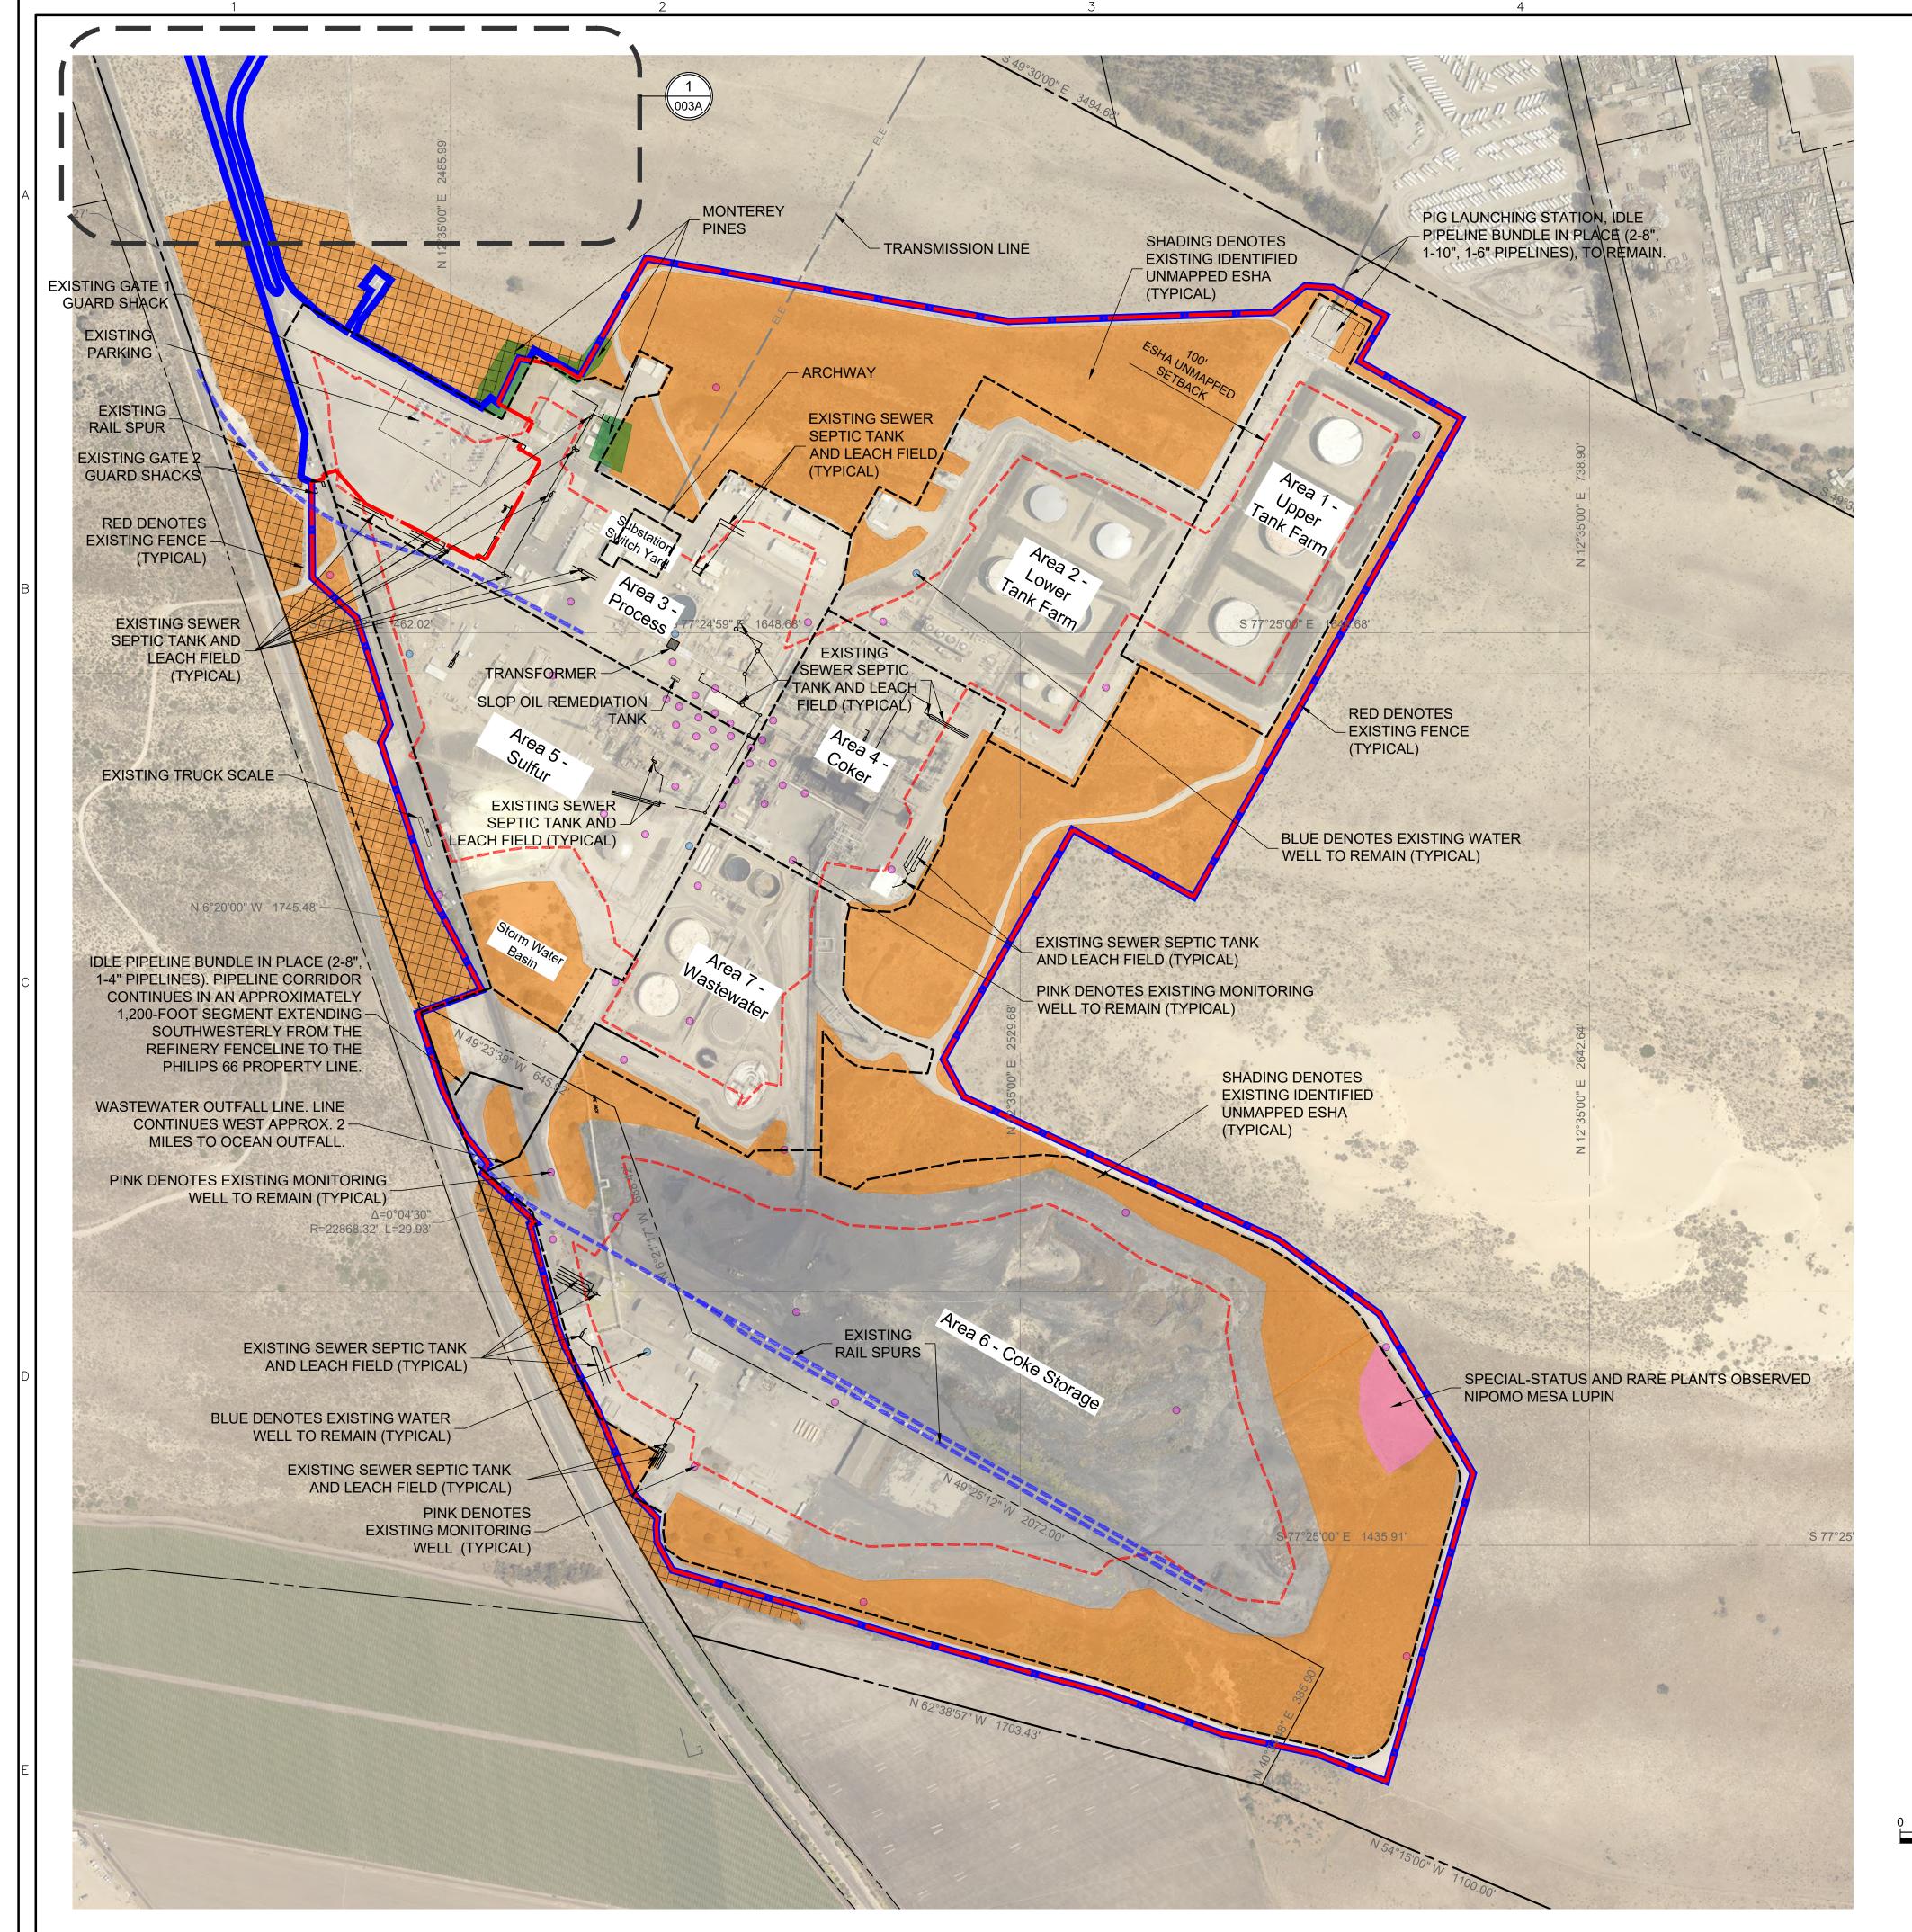

LEGEND:

PROJECT BOUNDARY




ESHA OUTSIDE PROJECT BOUNDARY (SHOWN FOR INFORMATION ONLY).

REFINERY AREA BREAKDOWN

	AREA LOCATION			
LOCATION	INSIDE FENCELINE (AC)	OUTSIDE FENCELINE (AC)		
AREA 1 - UPPER TANK	12.31	(AC)		
AREA 2 - LOWER TANK	15.61			
AREA 3- PROCESS ¹	14.25 6.4			
AREA 4 - COKER	9.72			
AREA 5 - SULFUR	19.47			
AREA 6 - COKE STORAGE	79.35			
AREA 7 - WASTEWATER	11.90			
AREA 8 - REMAINDER OF SITE ²	45.61 3.0			
SUBTOTAL	208.22			
TOTAL AREA WITHIN PROJECT BOUNDARY	217	217.74		

WORK OUTSIDE OF FENCELINE INCLUDES PARING LOT AND GRAVEL AREA. 2. AREA 8 CONSISTS OF ENTRY ROADS, VARIOUS PERIMETER ROADS AND OPEN SPACE NOT INCLUDED IN DEFINED AREAS 1-7.

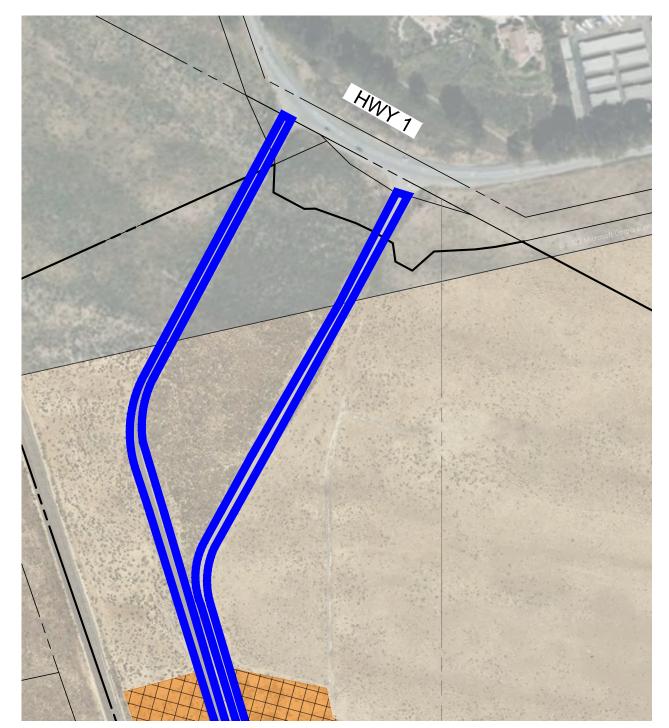

PROJECT ENTRANCE AT HIGHWAY 1

FOR REFERENCE ONLY

GRAPHIC SCALE

(IN FEET) 1 IN = 250 FT

SCALE: NTS

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3 10-31-23 UPDATED PROJECT INFORMATION

2 10-13-23 UPDATED PROJECT INFORMATION

1 09-20-23 UPDATED PROJECT INFORMATION

0 02-15-23 ISSUE FOR PERMITTING



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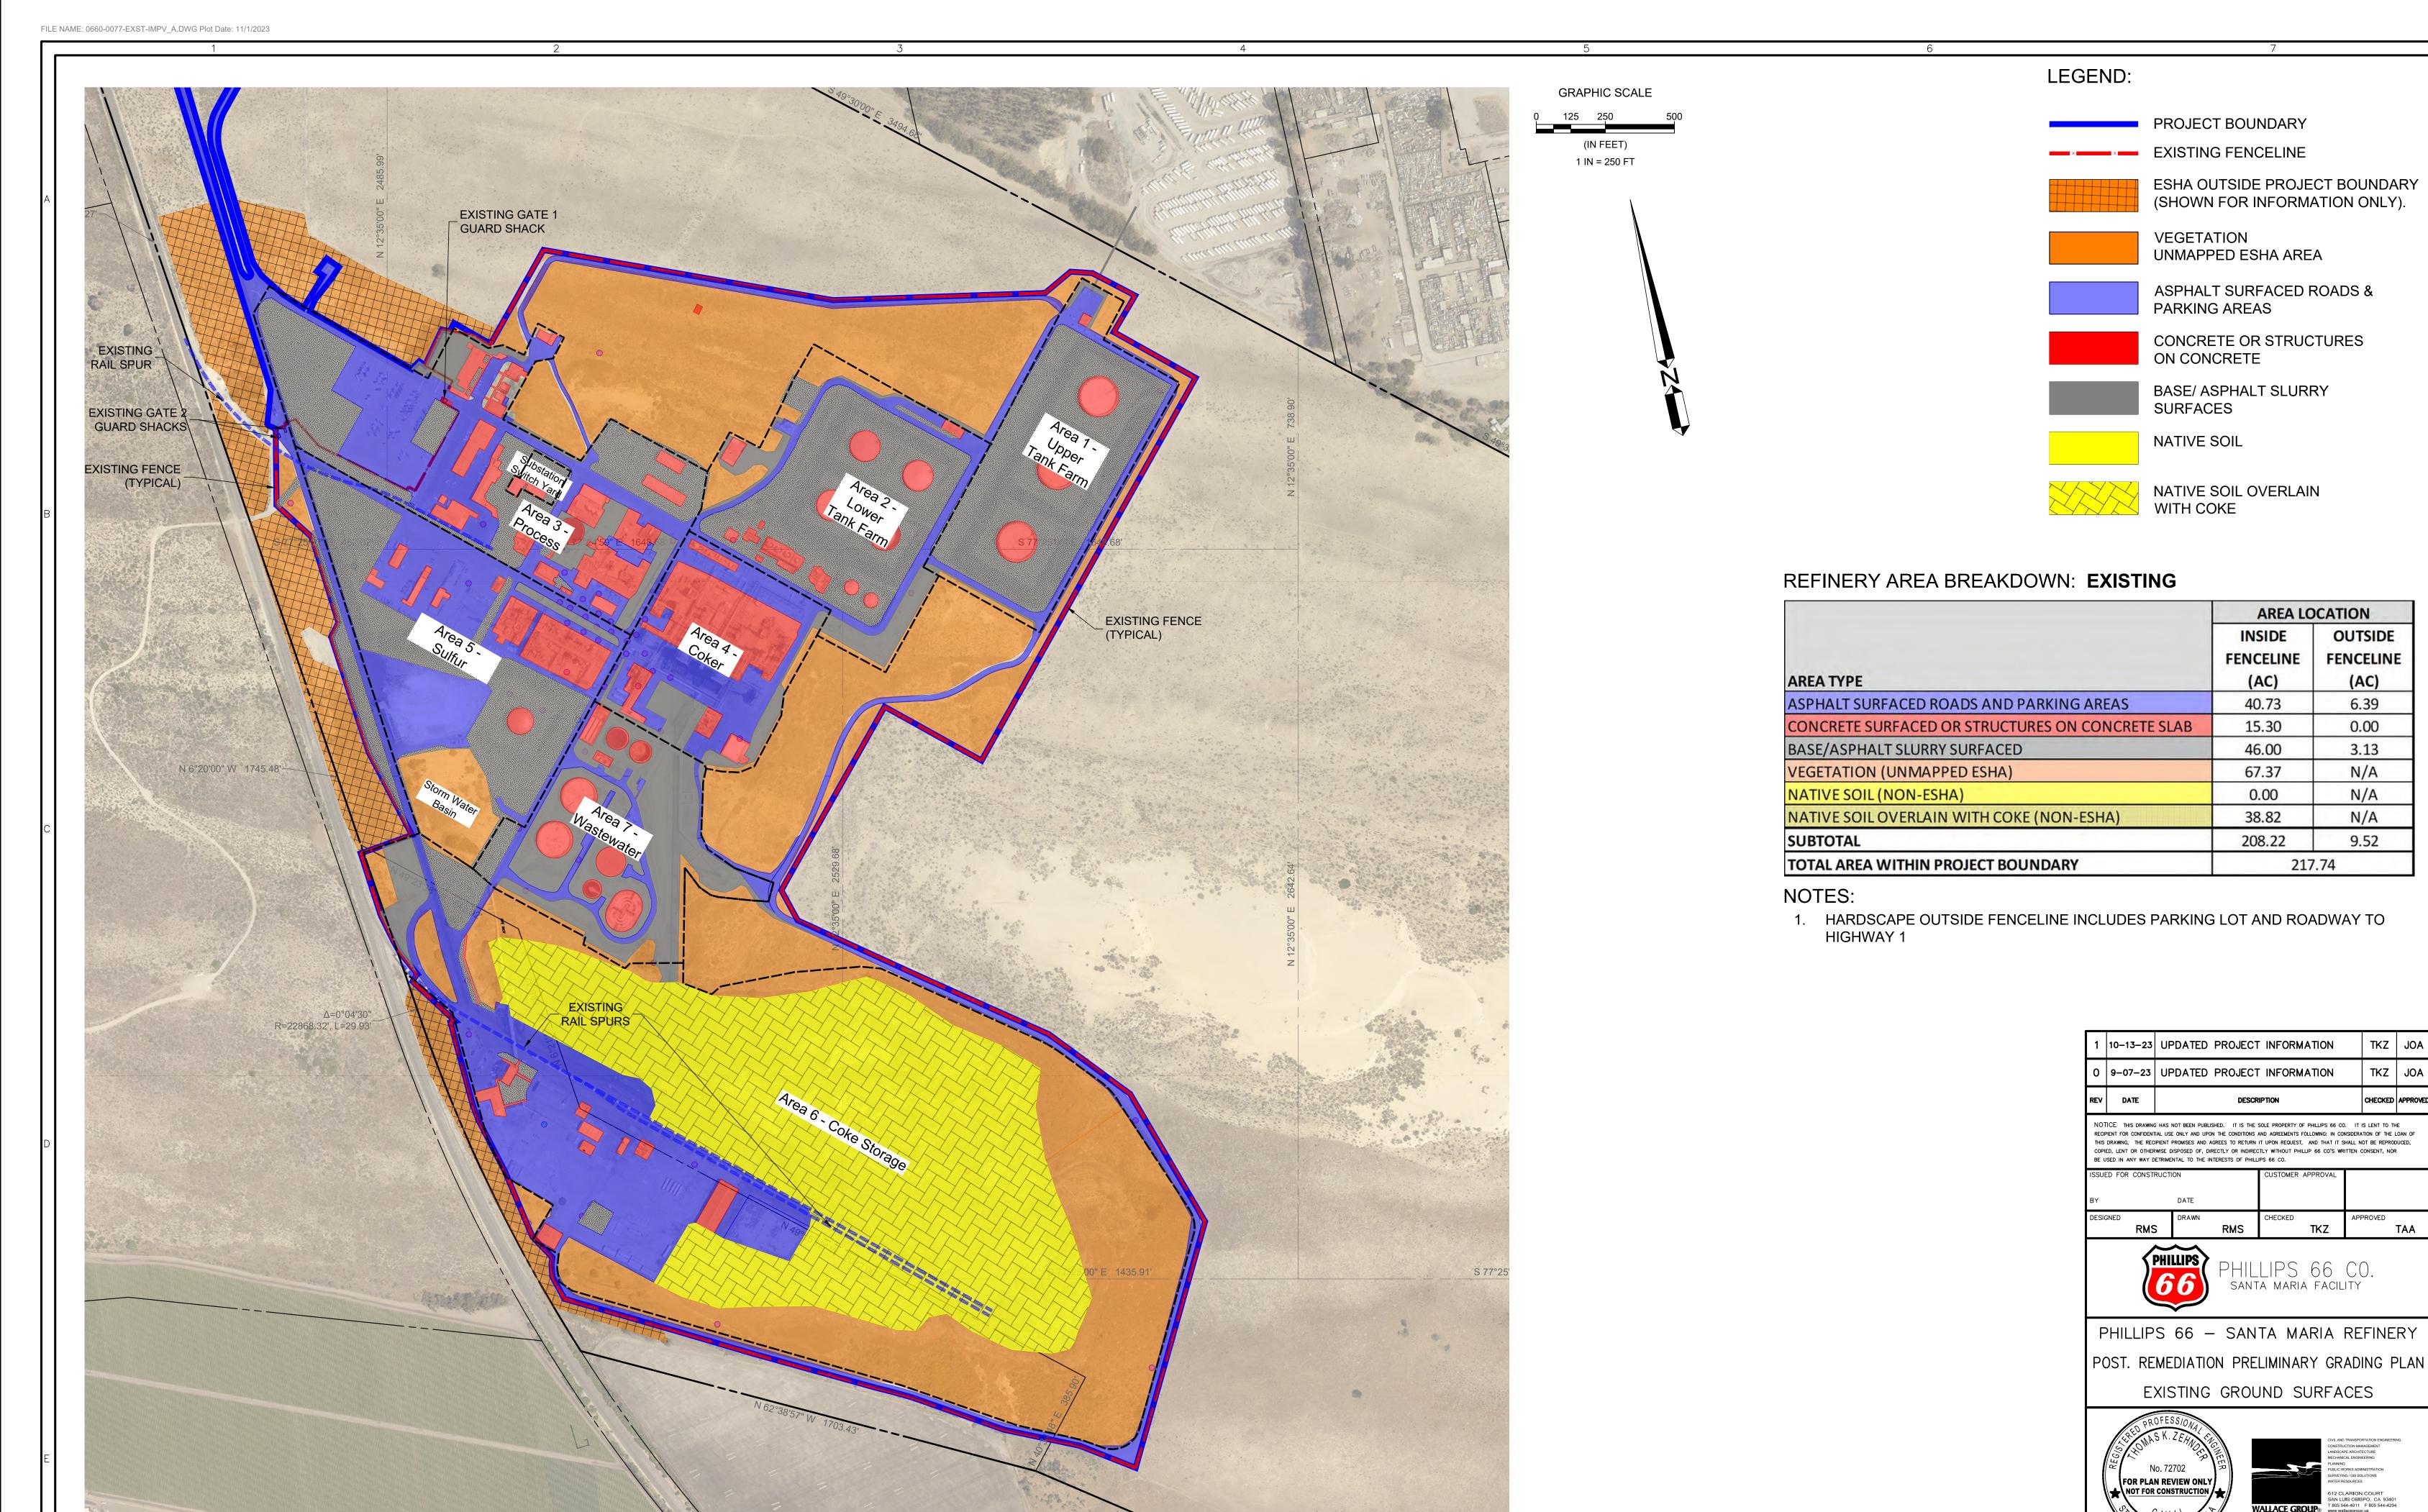
PHILLIPS 66 - SANTA MARIA REFINERY POST REMEDIATION PRELIMINARY GRADING PLAN EXISTING SITE PLAN





AS SHOWN

EIR-GP-EXT-003A PROPOSED PROJECT



B-4

AS SHOWN

EIR-GP-EXT-004A
PROPOSED PROJECT

